
APPROVAL CERTIFICATE

THIS SIP HAS BEEN REVIEWED AND FOUND TO BE COMPLETE AND IN ACCORD WITH CITY REGULATIONS. AS APPROVED BY THE CITY ON (Printed Name) (Signature) TITLE: COMMUNITY DEVELOPMENT DIRECTOR (Printed Name) _(Signature) TITLE: DIRECTOR OF PUBLIC WORKS (OR HIS/HER DESIGNATED RÉPRESENTATIVE) (Printed Name) (Signature) _ TITLE: MAYOR THE OWNER(S) OF THE LANDS DESCRIBED HEREIN, HEREBY AGREE(S) (1) TO DEVELOP AND MAINTAIN THE PROPERTY DESCRIBED HEREON IN ACCORDANCE WITH THIS APPROVED SITE IMPROVEMENT PLAN AND IN COMPLIANCE WITH CHAPTER 16 OF THE LONE TREE MUNICIPAL CODE AND THAT (2) THE HEIRS, SUCCESSOR AND ASSIGNS OF THE OWNER(S) SHALL ALSO BE BOUND. THE SIGNATURE OF THE OWNER(S)'(S) REPRESENTATIVE(S) BELOW INDICATE THAT ANY REQUIRED AUTHORIZATIONS TO ENTER THIS AGREEMENT, INCLUDING ANY CORPORATE AUTHORIZATIONS, HAVE BEEN OBTAINED. (NAME OF OWNER) (SIGNATURE OF OWNER) (PRINTED NAME & TITLE)

Heritage Hills Filing No. 2, 2nd Amendment, Lots 7A-1, 8A-1, & 8A-2 Heritage Hills Planned Development Planning Area #9 5.23 Acres SIP #SP20-78

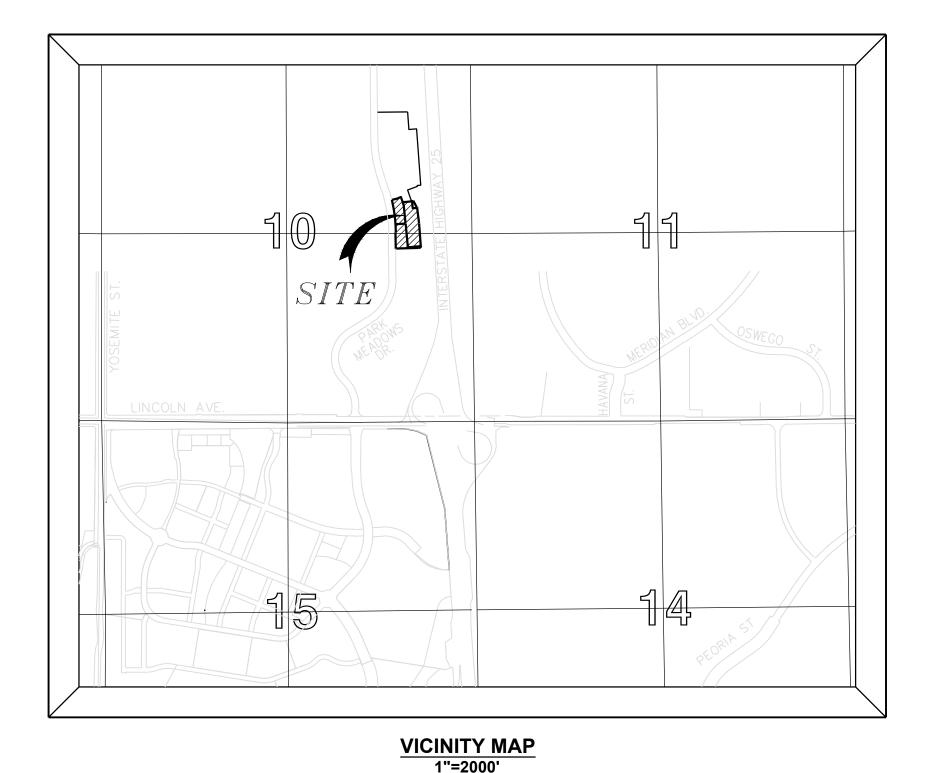

OWNER/DEVELOPER CENTURY COMMUNITIES GREENWOOD VILLAGE, CO 80111 CHRIS WINCHESTER

ARCHITECT 820 16TH STREET MALL #500 DENVER, CO 80202

P: 303.751.0741

JENNAFER DAUWALTER P: 303.825.6400 **CIVIL ENGINEER** MERRICK & COMPAN'

5970 GREENWOOD PLAZA BLVD GREENWOOD VILLAGE, CO 8011 KRISTOFER K. WIEST, P.E.

01 of 35

SHEET INDEX

COVER SHEET SITE PLAN PARKING GARAGE LEVEL 1 FLOOR PLAN PARKING GARAGE LEVEL 2 FLOOR PLAN PARKING GARAGE LEVEL 3 FLOOR PLAN **GRADING PLAN** 07 of 35 UTILITY PLAN OVERALL LANDSCAPE PLAN LANDSCAPE ENLARGEMENTS LANDSCAPE ENLARGEMENTS SITE FURNISHING PLAN LANDSCAPE DETAILS LANDSCAPE DETAILS PLANT SCHEDULE & NOTES

IRRIGATION NOTES, SCHEDULE & DETAILS IRRIGATION PLAN OVERALL IRRIGATION ENLARGEMENTS

IRRIGATION ENLARGEMENTS IRRIGATION ENLARGEMENTS IRRIGATION ENLARGEMENTS SITE PHOTOMETRIC PLAN 25 of 35 LIGHT SPECIFICATIONS 26 of 35

27 of 35 LIGHT SPECIFICATIONS OVERALL BUILDING ELEVATIONS

NORTHEAST COURTYARD & PRIVATE DRIVE ELEVATIONS

NORTH & SOUTH COURTYARD ELEVATIONS 30 of 35 31 of 35 BUILDING RENDERINGS BUILDING RENDERINGS 32 of 35 BUILDING RENDERINGS 33 of 35

34 of 35 BUILDING RENDERINGS 35 of 35 BUILDING RENDERINGS

PROJECT DIRECTORY

8390 E CRESCENT PKWY, STE 650 P: 303.551.8426

> P: 303.224.9520 MERRICK & COMPANY

LANDSCAPE ARCHITECT

2755 SOUTH LOCUST STREET, SUITE 236

CONSILIUM DESIGN

DENVER, CO 80222

JULIE HENDRICKSEN

5970 GREENWOOD PLAZA BLVD. GREENWOOD VILLAGE, CO 80111 KENNETH OUELLETTE, P.L.S. P: 303.751.0741

> PREPARED FOR CENTURY COMMUNITIES

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Planning | Geospatial Solutions

ww.merrick.com

970 GREENWOOD PLAZA BLVD.

REENWOOD VILLAGE, CO. 80111

PROJECT NUMBER

65120692

DRAWN BY

DATE

7/23/2021

REVISIONS

REVISION 2

REVISION 4

REVISION 1 FEB 10, 2021

REVISION 3 JUNE 10, 2021

REVISION 5 JULY 23, 2021

MAR 16, 2021

JULY 6, 2021



PROJECT

LINCOLN **STATION APARTMENTS**

LONE TREE, COLORADO

SHEET TITLE

COVER SHEET

SHEET NUMBER

OF 35

STANDARD CONDITIONS OF APPROVAL (PER CITY OF LONE TREE MUNICIPAL CODE SECTION 16-27-70(b)(1):

COUNTY OF:

SUBSCRIBED AND SWORN TO BEFORE ME THIS

WITNESS MY HAND AND OFFICIAL SEAL.

MY COMMISSION EXPIRES:

NOTARY PUBLIC

1.THE PROPERTY HEREIN IS SUBJECT TO ALL APPLICABLE REQUIREMENTS OF THE LONE TREE ZONING CODE, INCLUDING BUT NOT LIMITED TO MAINTENANCE, LIGHTING, PARKING, SIGNAGE, AND OUTDOOR STORAGE, EXCEPT AS MAY OTHERWISE BE ADDRESSED IN AN APPROVED DEVELOPMENT PLAN OR SUB-AREA PLAN.

ACT (ADA) HAVE BEEN SATISFIED. THE APPLICANT IS RESPONSIBLE TO ENSURE THAT SAID ADA REQUIREMENTS HAVE BEEN

2. THE APPLICANT ASSUMES RESPONSIBILITY TO ENSURE THE PROJECT IS COMPLETED IN ACCORDANCE WITH THE APPROVED SIP AND ANY ASSOCIATED MATERIALS SAMPLE BOARDS AND FURTHER ASSUMES THE RISK ASSOCIATED WITH ANY CHANGES OR OMISSIONS MADE WITHOUT PRIOR CITY APPROVAL. MODIFICATIONS TO STRUCTURES OR SITES MAY REQUIRE AN AMENDMENT TO THE SIP AS DETERMINED BY THE DIRECTOR. UNAUTHORIZED CHANGES OR OMISSIONS MAY RESULT IN CORRECTIVE ACTIONS, DELAY OF PERMITS OR CITATIONS FOR ZONING VIOLATIONS WITH ASSOCIATED FINES AND LEGAL MEASURES. BUILDING PLANS SHALL CONFORM TO THE APPROVED SIP.

DAY OF , 20 , BY

3. WITHIN SITE TRIANGLES, AS SHOWN, LIMITED LANDSCAPING SHALL BE ALLOWED WITH NO SOLID STRUCTURES PERMITTED AS STATED IN THE CITY OF LONE TREE'S LANDSCAPE DESIGN GUIDELINES AND STANDARDS FOR AREAS IN AND ALONG PUBLIC RIGHTS-OF-WAY. LANDSCAPING WITHIN THE SITE TRIANGLE SHALL BE MAINTAINED BY THE PROPERTY OWNER OR APPROPRIATE ASSOCIATION OR DISTRICT, AS MAY BE IDENTIFIED BY MAINTENANCE AGREEMENTS.

4. THE OWNER/DEVELOPER IS RESPONSIBLE FOR INSTALLATION OF ALL ROADWAY SIGNAGE, INCLUDING "NO PARKING/FIRE LANE" SIGNAGE, AS REQUIRED BY THE CITY PUBLIC WORKS DEPARTMENT AND FIRE DISTRICT. THE OWNER/ASSOCIATION SHALL MAINTAIN SAID SIGNAGE.

5. ACCORDING TO THE FEDERAL EMERGENCY MANAGEMENT AGENCY, NATIONAL FLOOD INSURANCE PROGRAM, FLOOD INSURANCE RATE MAP FOR CITY OF LONE TREE, DOUGLAS COUNTY, COLORADO, COMMUNITY-PANEL NUMBER 0061H, MAP NUMBER 08035C0061H, DATED FEBRUARY 17, 2017, THE SUBJECT PROPERTY LINES WITHIN ZONE X, "AREAS DETERMINED TO BE OUTSIDE OF THE 0.2% ANNUAL CHANCE FLOODPLAIN".

6. DEVELOPER IS RESPONSIBLE FOR INSTALLING PARKING SIGNS THAT:

1)RESTRICT THE SURFACE PARKING LOT TO ACCESSIBLE, CUSTOMER AND PROSPECTIVE TENANT PARKING

AND LOADING/DELIVERIES AND 2) PROHIBIT RESIDENTIAL VISITOR PARKING. ALL TENANT, VISITOR AND EMPLOYEE PARKING MUST BE RESTRICTED TO THE PARKING STRUCTURE.

7. THE DEVELOPER IS RESPONSIBLE FOR INSTALLING A RESTRICTIVE ACCESS SIGNS AT THE ENTRANCE TO THE SURFACE PARKING LOT TO ENSURE NO TRUCKS LONGER THAN TWENTY-THREE FEET ENTER THE PARKING AREA.

8. IT SHALL BE THE OWNER'S RESPONSIBILITY TO TO MAINTAIN ALL IMPROVEMENTS ON THE PROPERTY IN A STATE OF GOOD REPAIR, CONSISTENT WITH THE APPROVED SIP AND THE LONE TREE MUNICIPAL CODE. IT IS THE OWNER'S RESPONSIBILITY TO MAINTAIN SITE LANDSCAPING, AND TO EMPTY AND REFILL ALL PET WASTE STATION ON THE PROPERTY.


9. THE CITY OF LONE TREE REQUIRES THAT MAINTENANCE ACCESS BE PROVIDED TO ALL STORM DRAINAGE FACILITIES TO ASSURE CONTINUOUS OPERATION CAPABILITY OF THE SYSTEM. THE PROPERTY OWNER SHALL BE RESPONSIBLE FOR THE MAINTENANCE OF ALL DRAINAGE FACILITIES, INCLUDING INLETS, PIPES, CULVERTS, CHANNELS, DITCHES, HYDRAULIC STRUCTURES AND DETENTION BASINS LOCATED ON THEIR LAND UNLESS MODIFIED BY THE SITE IMPROVEMENT PLAN IMPROVEMENTS AGREEMENT. SHOULD THE OWNER FAIL TO ADEQUATELY MAINTAIN SAID FACILITIES, THE CITY OF LONE TREE SHALL HAVE THE RIGHT TO ENTER SAID LAND FOR THE PURPOSES OF OPERATIONS AND MAINTENANCE. ALL SUCH MAINTENANCE COSTS WILL BE ASSES TO THE PROPERTY OWNER.

10. ALL PRESENT AND FUTURE OWNERS AND OCCUPANTS OF LAND HEREBY SUBJECT TO A SITE IMPROVEMENT PLAN ARE HEREBY NOTIFIED THAT THE PROPERTY IS LOCATED WITHIN PROXIMITY TO CENTENNIAL AIRPORT AND IS SUBJECT TO THE TERMS OF THAT CERTAIN AVIGATION AND HAZARD EASEMENT RECORDED AT RECEPTION NUMBER 9710387 ON FEBRUARY 26, 1997 IN THE RECORDS OF THE DOUGLAS COUNTY CLERK AND RECORDER, AND AS MAY BE AMENDED.

11. PROXIMITY TO CENTENNIAL AIRPORT MAY HAVE ANY NUMBER OF IMPACTS ON THE PROPERTY OCCUPANTS, THE PROPERTY, AND THE DEVELOPMENT, IMPROVEMENT, USE, ENJOYMENT OR OCCUPANCY OF THE PROPERTY, INCLUDING WITHOUT LIMITATION ODORS, AIRCRAFT NOISE, VIBRATION, FUMES, FUEL PARTICLES, EXHAUST, AND THE OPERATION AND PASSAGE OF AIRCRAFT ABOVE OR NEAR THE PROPERTY. INDIVIDUAL SENSITIVITIES TO THE POTENTIAL CENTENNIAL AIRPORT IMPACTS CAN VARY FROM PERSON TO PERSON, AND POTENTIAL AIRPORT IMPACTS CAN VARY FROM LOCATION TO LOCATION WITHIN THE PROPERTY AND FROM TIME TO TIME. RECORDS AND INFORMATION CONCERNING CENTENNIAL AIRPORT AND POTENTIAL AIRPORT IMPACTS ARE PUBLICLY AVAILABLE THROUGH VARIOUS FEDERAL, STATE, AND LOCAL GOVERNMENTAL AGENCIES, INCLUDING CENTENNIAL AIRPORT. ALL PRESENT AND FUTURE OWNERS AND OCCUPANTS ARE SOLELY RESPONSIBLE FOR EVALUATING AND DETERMINING WETHER THE AIRPORT IMPACTS, IF ANY, ARE ACCEPTABLE TO THEM.


12. RESTAURANT OR FAST FOOD ESTABLISHMENTS SHALL BE REVIEWED BY THE CITY OF LONE TREE FOR ADEQUATE PARKING PER THE LONE TREE ZONING CODE PRIOR TO THE ISSUANCE OF BUILDING PERMITS FOR SUCH SPACES; CHANGES IN USE MAY NECESSITATE AMENDMENTS TO THE SIP.

13. RTD MUST AUTHORIZE THE REMOVAL OR RELOCATION OF THE EXISTING 'NO ENTRY' AND 'BUSES EXCEPTED' SIGNS AS APPROVED BY THE CITY, PRIOR TO CERTIFICATE OF OCCUPANCY.

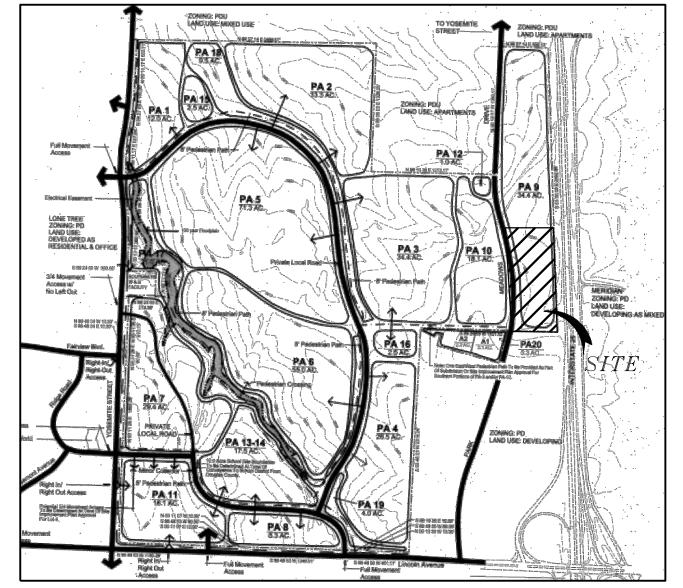

HERITAGE HILLS PLANNED DEVELOPMENT 9TH AMENDMENT



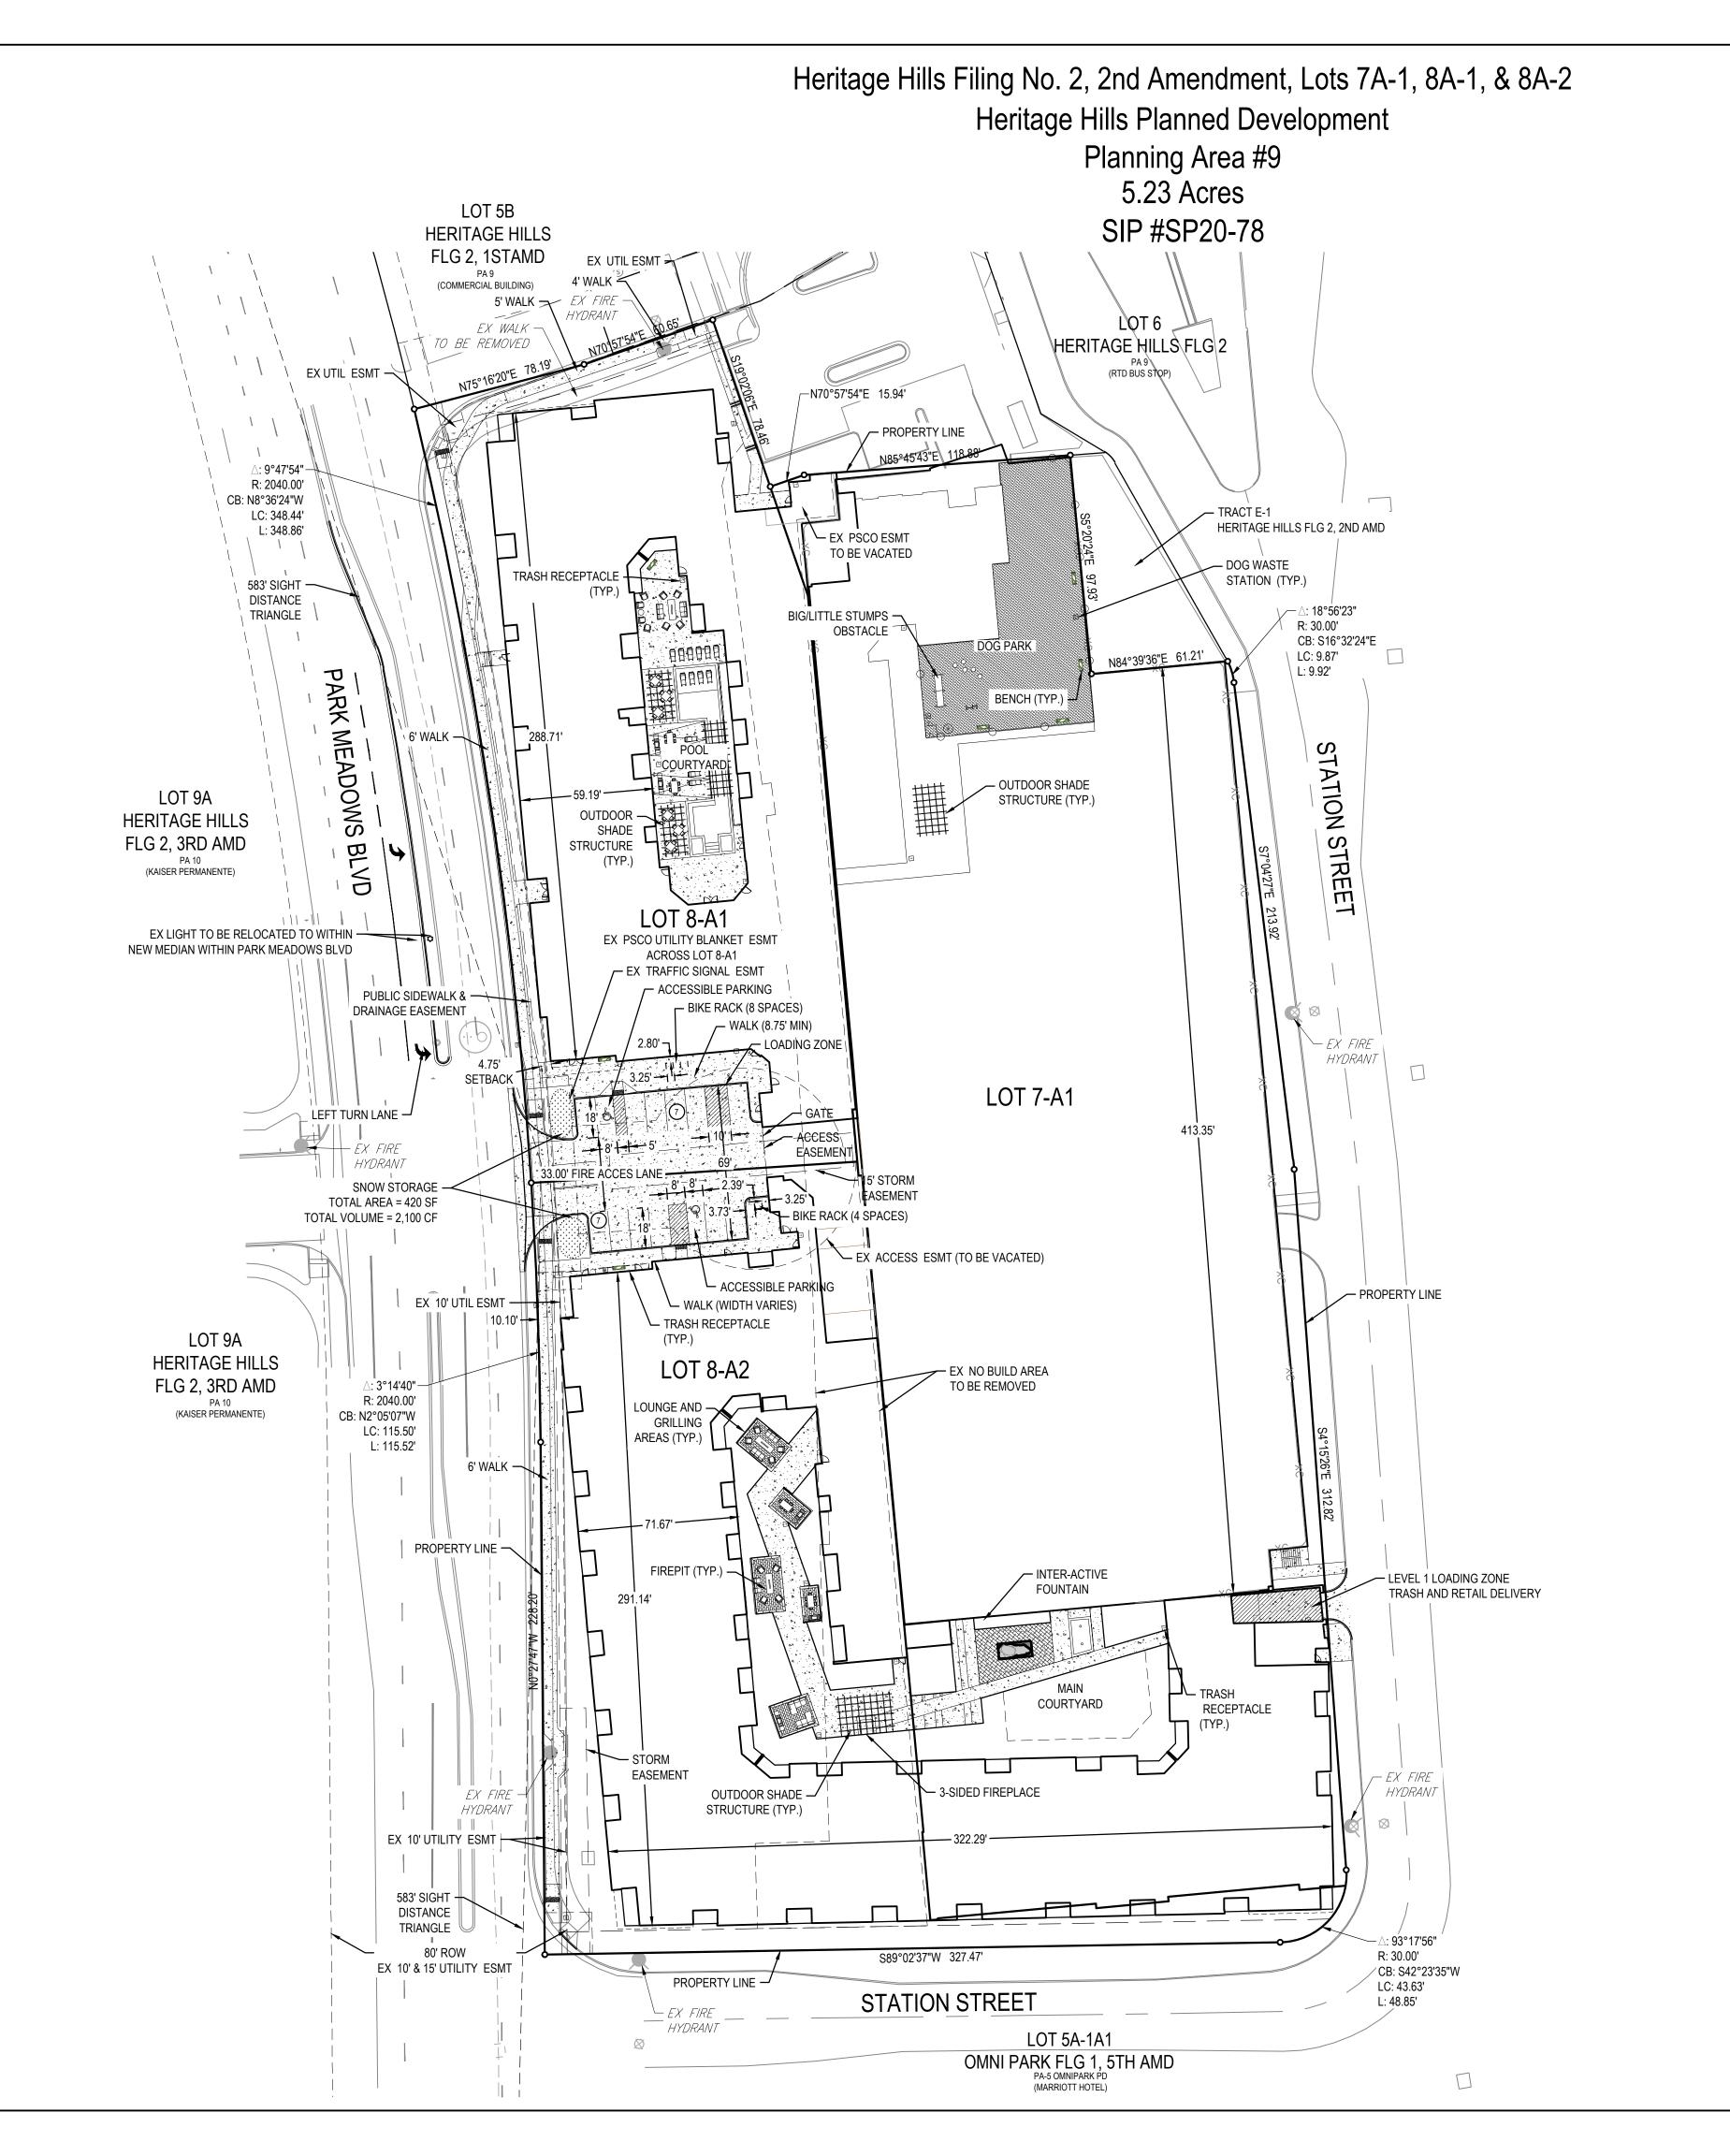

ITEM	SQUARE FOOTAGE	% OF GROSS SITE
GROSS SITE AREA	227,688 SF / 5.23 AC	100%
Total Building Footprint	168,831	68%
Existing Parking Structure	86,598	
Building Footprint (excludes ex parking structure)	82,233	
Parking/Roads	5,830	3%
Landscaped and Hardscaped areas	53,027	29%
Main Courtyard	15,054	
Pool Courtyard	5,306	
Dog Park	8,309	
ITEM		
Building Size		
Maximum height (as measured by the City's Building Code)	88' -	- 0"
Total Floor Area (sf)	441,	675
ITEM		
Parking		
Required	51	3
Provided	51	14
Bicycle Parking		
Required	1	1
Provided	12	

PARKING REQUIRED			
	NUMBER OF ROOMS	PARKING PER UNIT	TOTAL
STUDIO UNITS	8	1.3*	11
ONE BEDROOM UNITS	291	1.3*	378
TWO BEDROOM UNITS	106	1.3*	138
THREE BEDROOM UNITS	20	1.3*	26
	AREA (SF)		
RETAIL	3000 SF	4/1000 SF	12
LEASING	970 SF	4/1000 SF	4
		SUB-TOTAL PARKING	569
10% MAX REDUCTION PER FLG 2 FRAMEWORK PLAN			56
TOTAL PARKING REQUIRED			513
PARKING PROVIDED			
PARKING DECK (INCLUDES 8 STD & 2 VAN ACCESIBLE SPACES, AND 14 COMPACT SPACES)			500
ON-SITE OUTDOOR PARKING (INCLUDES 1 STD & 1 VAN ACCESSIBLE SPACE)			14
TOTAL PARKING PROVIDED			514

* PER HERITAGE HILLS FILING NO. 2 FRAMEWORK PLAN (LINCOLN STATION)

ALL GROUND MOUNTED OR BUILDING MOUNTED ELECTRIC METERS TO BE PAINTED TO MATCH


2. RETAIL FREIGHT DELIVERIES TO BE RESTRICTED TO NON-PEAK HOURS AND LOCATED AT THE

LOADING/UNLOADING ZONE OFF STATION STREET.

SURFACE PARKING TO BE RESTRICTED TO VEHICLES NO LONGER THAN 23-FT IN LENGTH. SIGNAGE TO THIS EFFECT WILL BE REQUIRED AND WILL BE APPROVED AS PART BY PUBLIC WORKS PRIOR TO PLAN APPROVAL.

- 1	FGFN	

LEGEND				
ш	PROPOSED BENCH			
	DOG WASTE RECEPTACLE			
	TRASH CAN			
	SITE FURNITURE			
0— Ю	PROPOSED LIGHTS			
	ARTIFICIAL TURF			
	SNOW STORAGE AREA			
GEN	PROPOSED GENERATOR			
<u></u>	CURB WITH PARKING OVERHANG			
─ ◇ ─ ◇ ─ ◇ ─ ◇	PROPOSED FENCING			

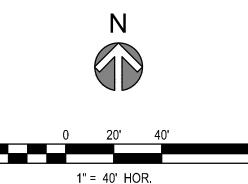

PROJECT NUMBER

65120692

DRAWN BY

DATE 7/06/2021

REVISIONS

REVISION 1 FEB 10, 2021 REVISION 2 MAR 16, 2021 REVISION 3 JUNE 10, 2021 REVISION 4 JULY 6, 2021

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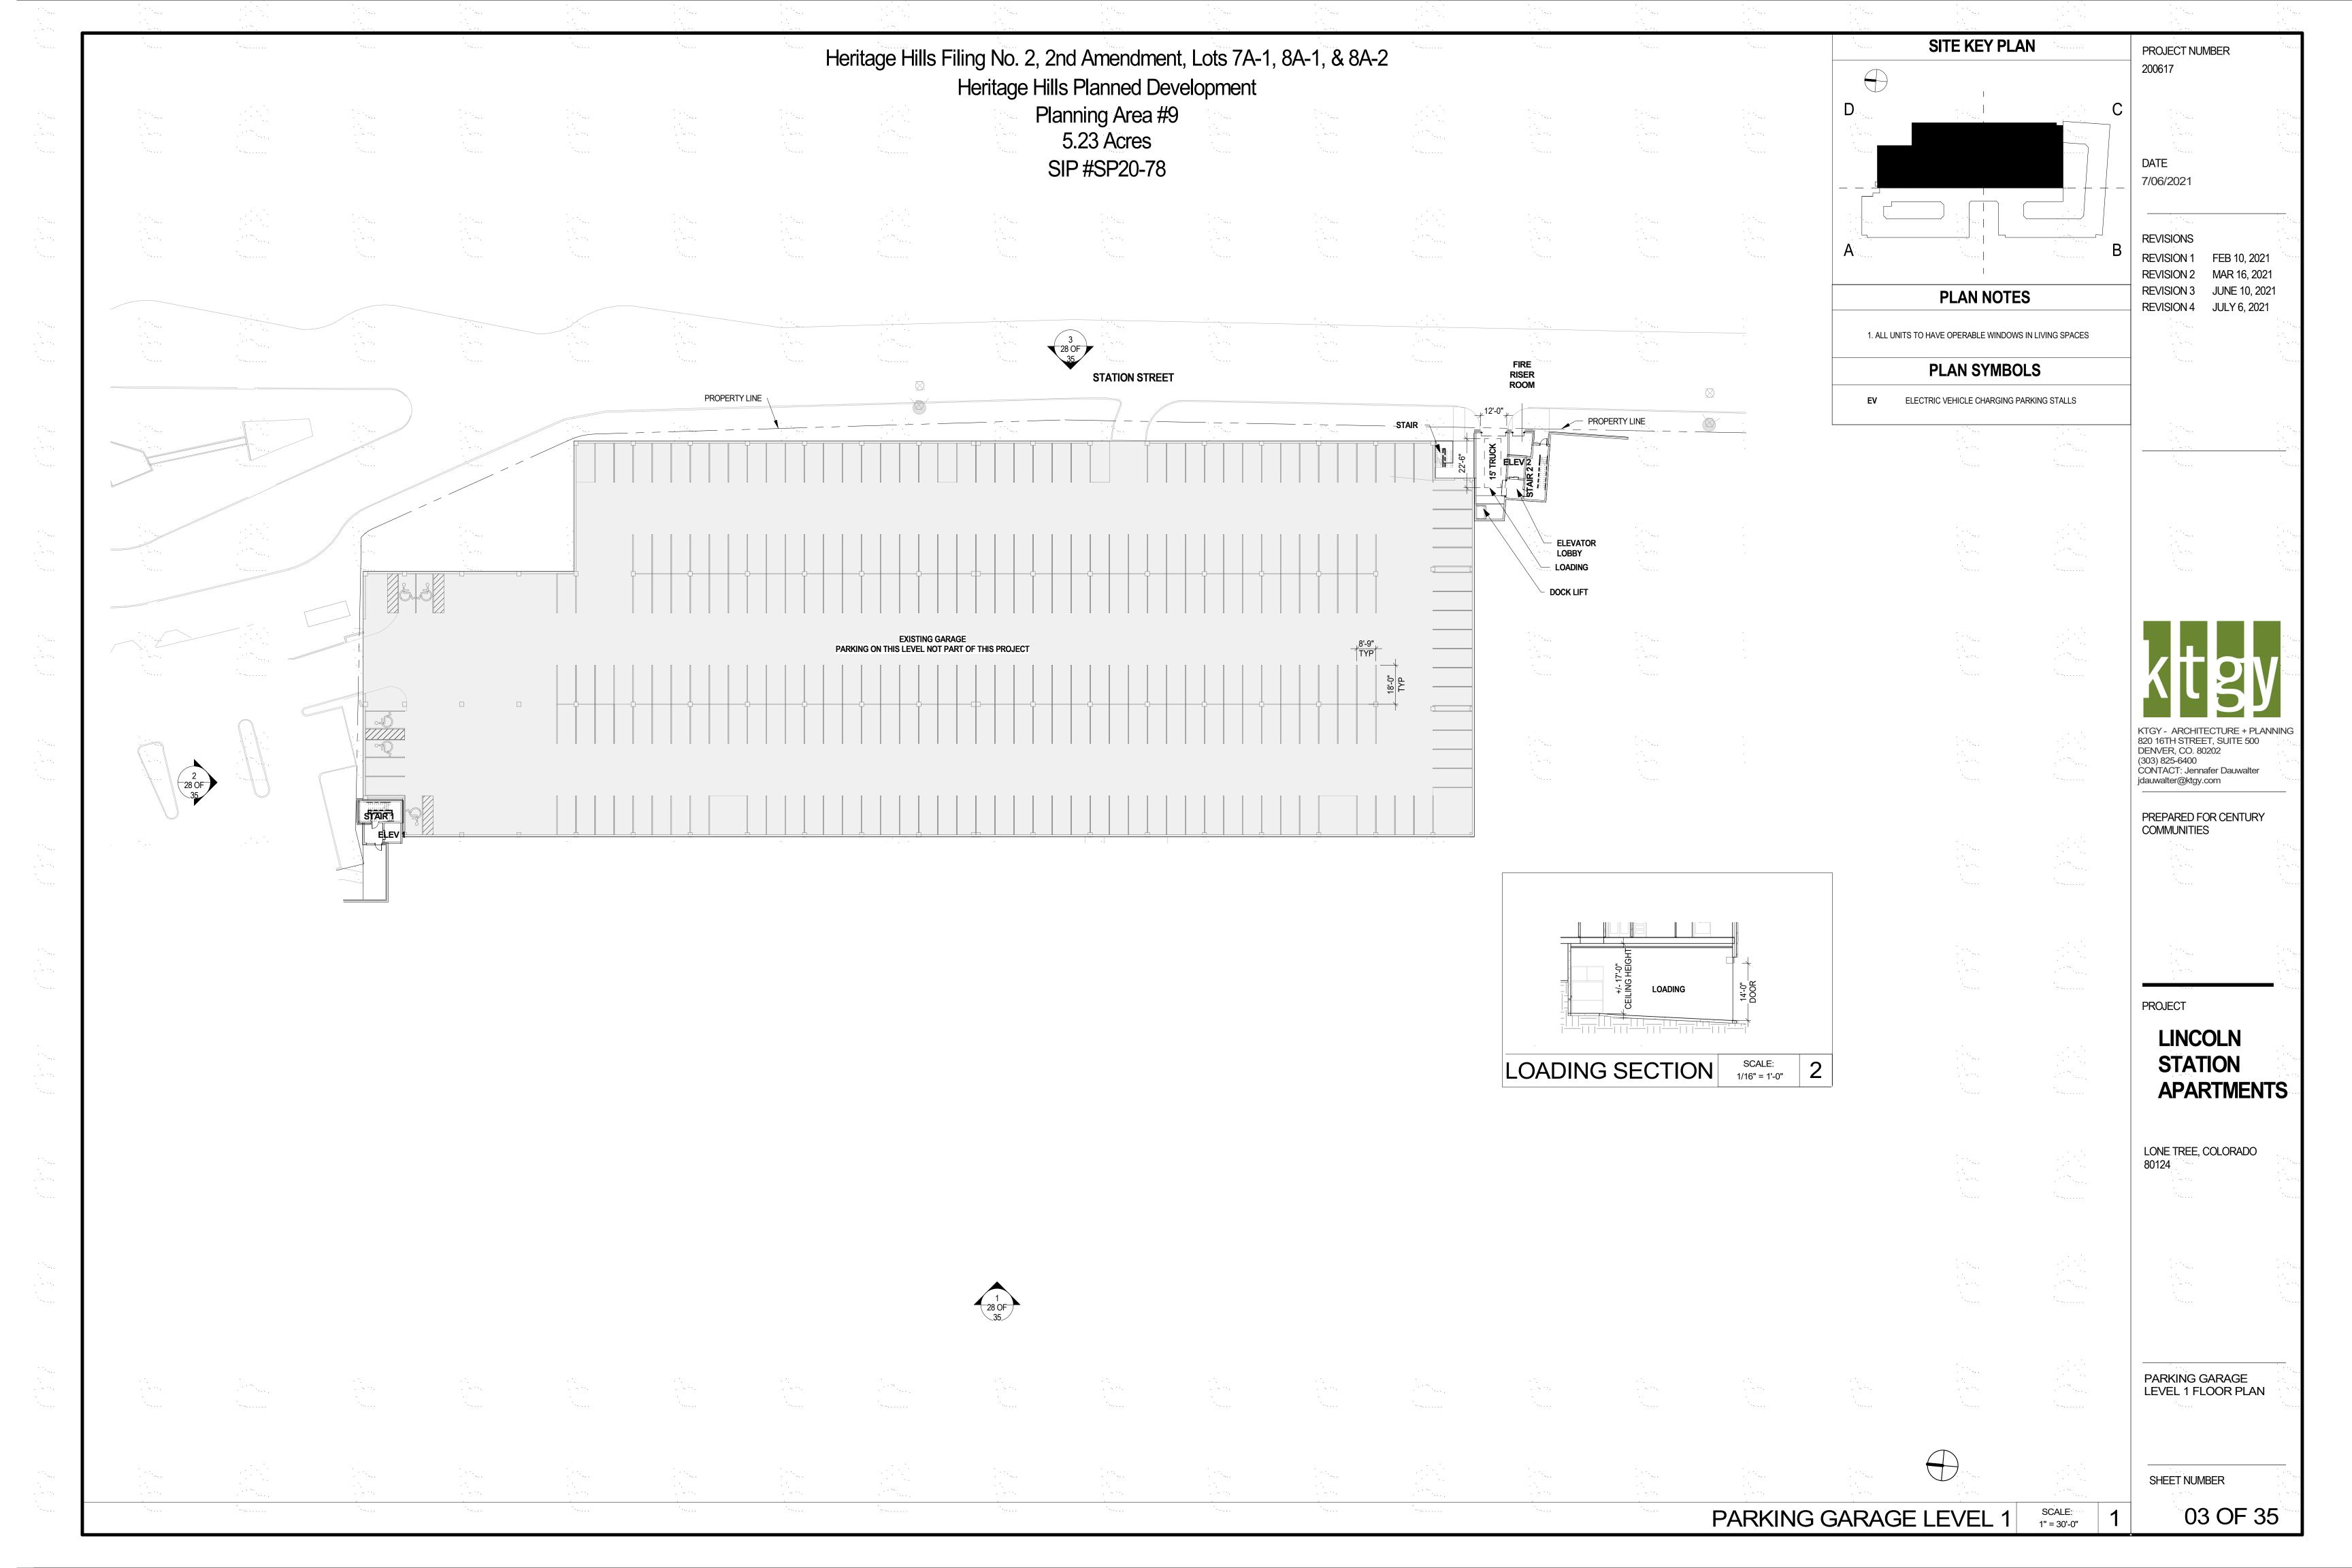
LINCOLN **STATION APARTMENTS**


LONE TREE, COLORADO


SHEET TITLE


SITE PLAN

SHEET NUMBER



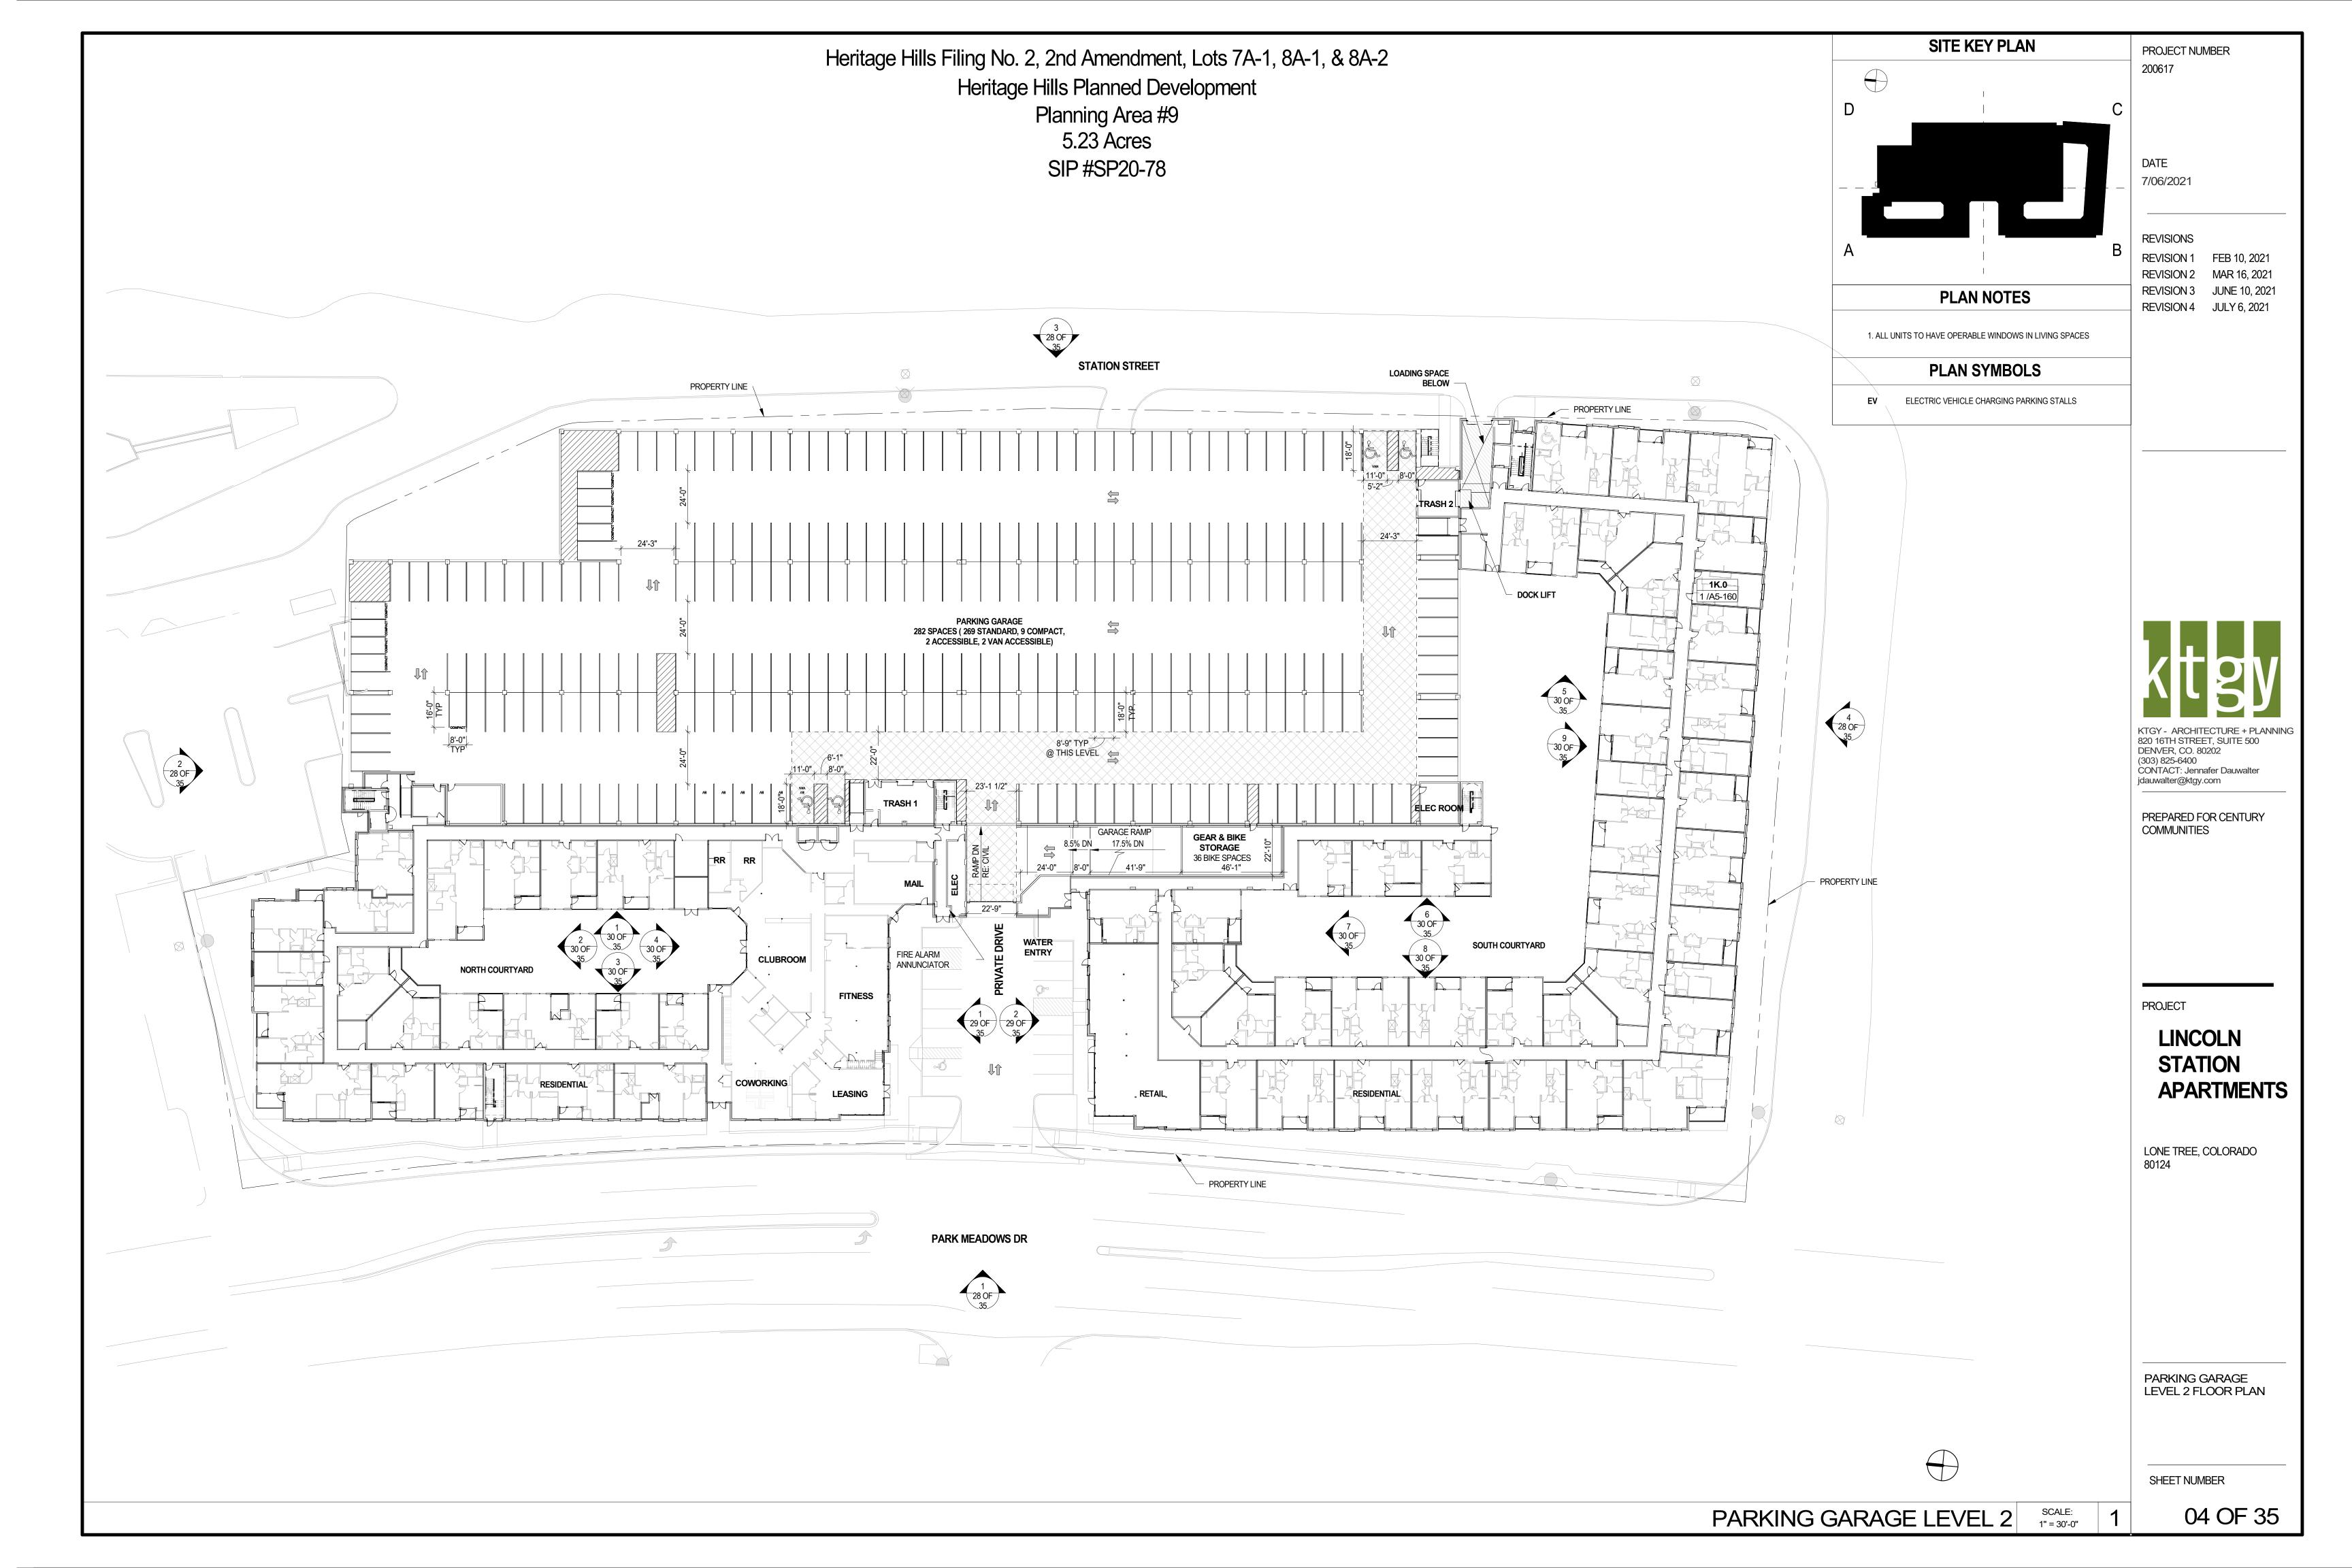

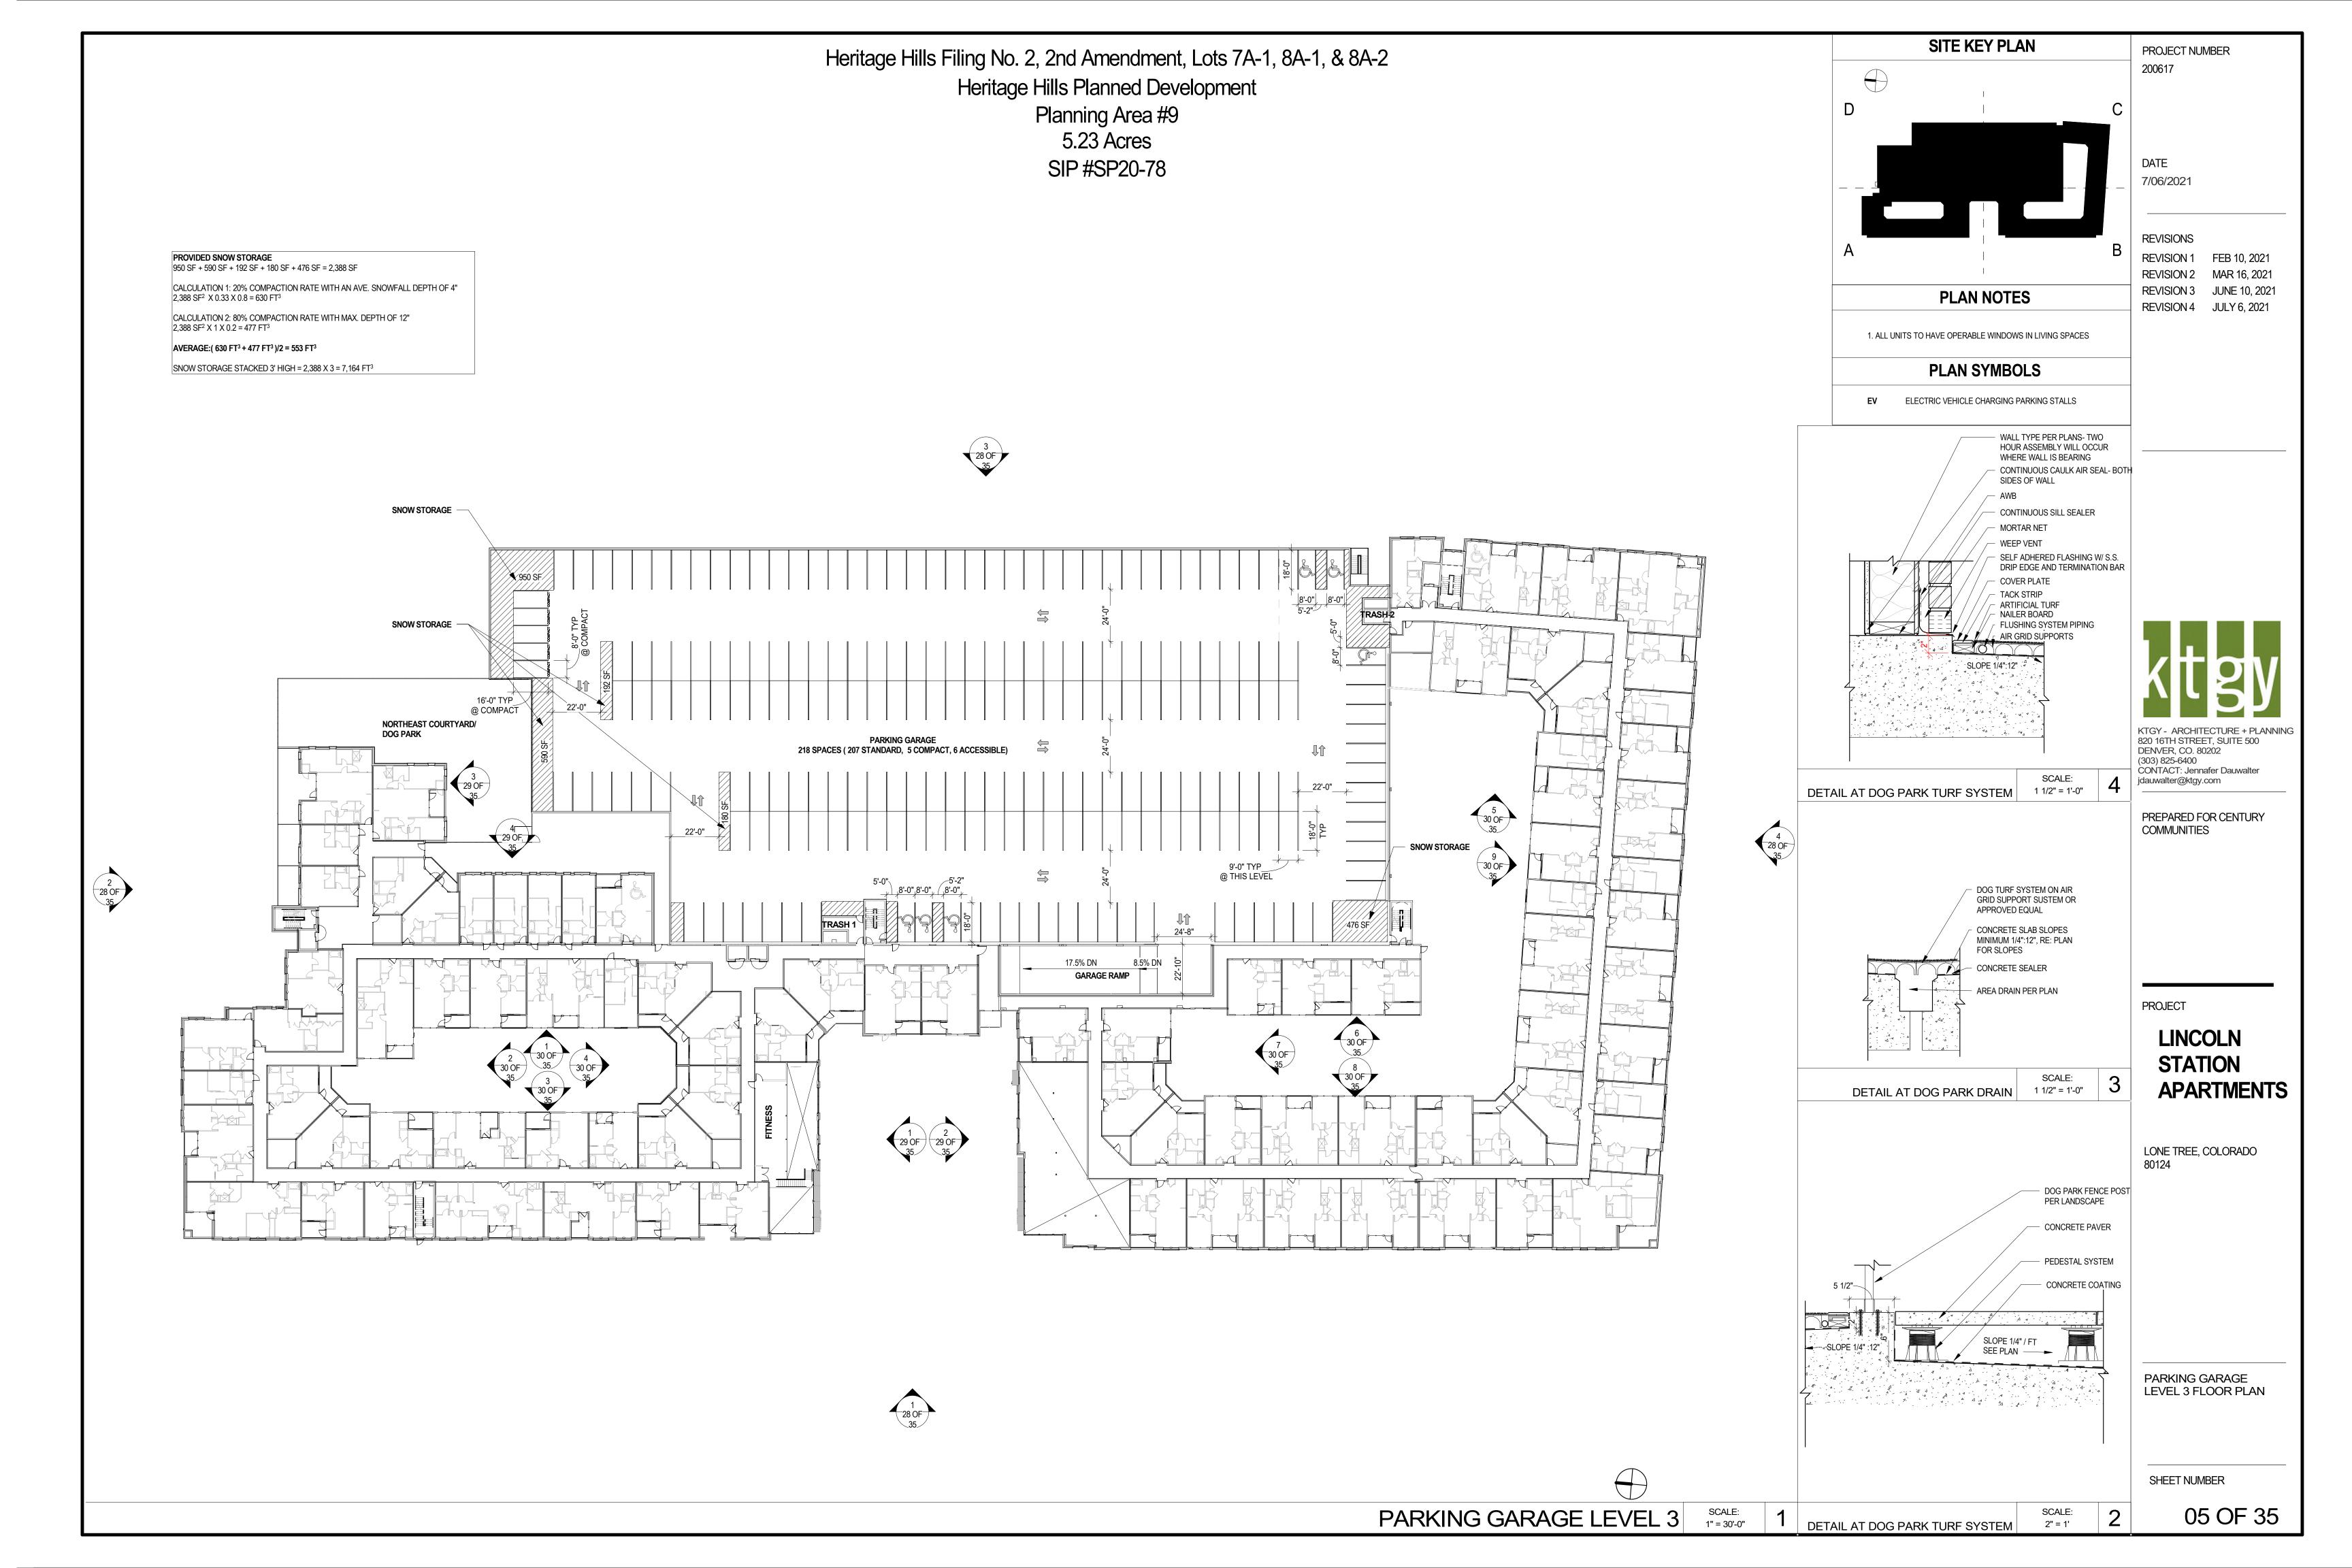

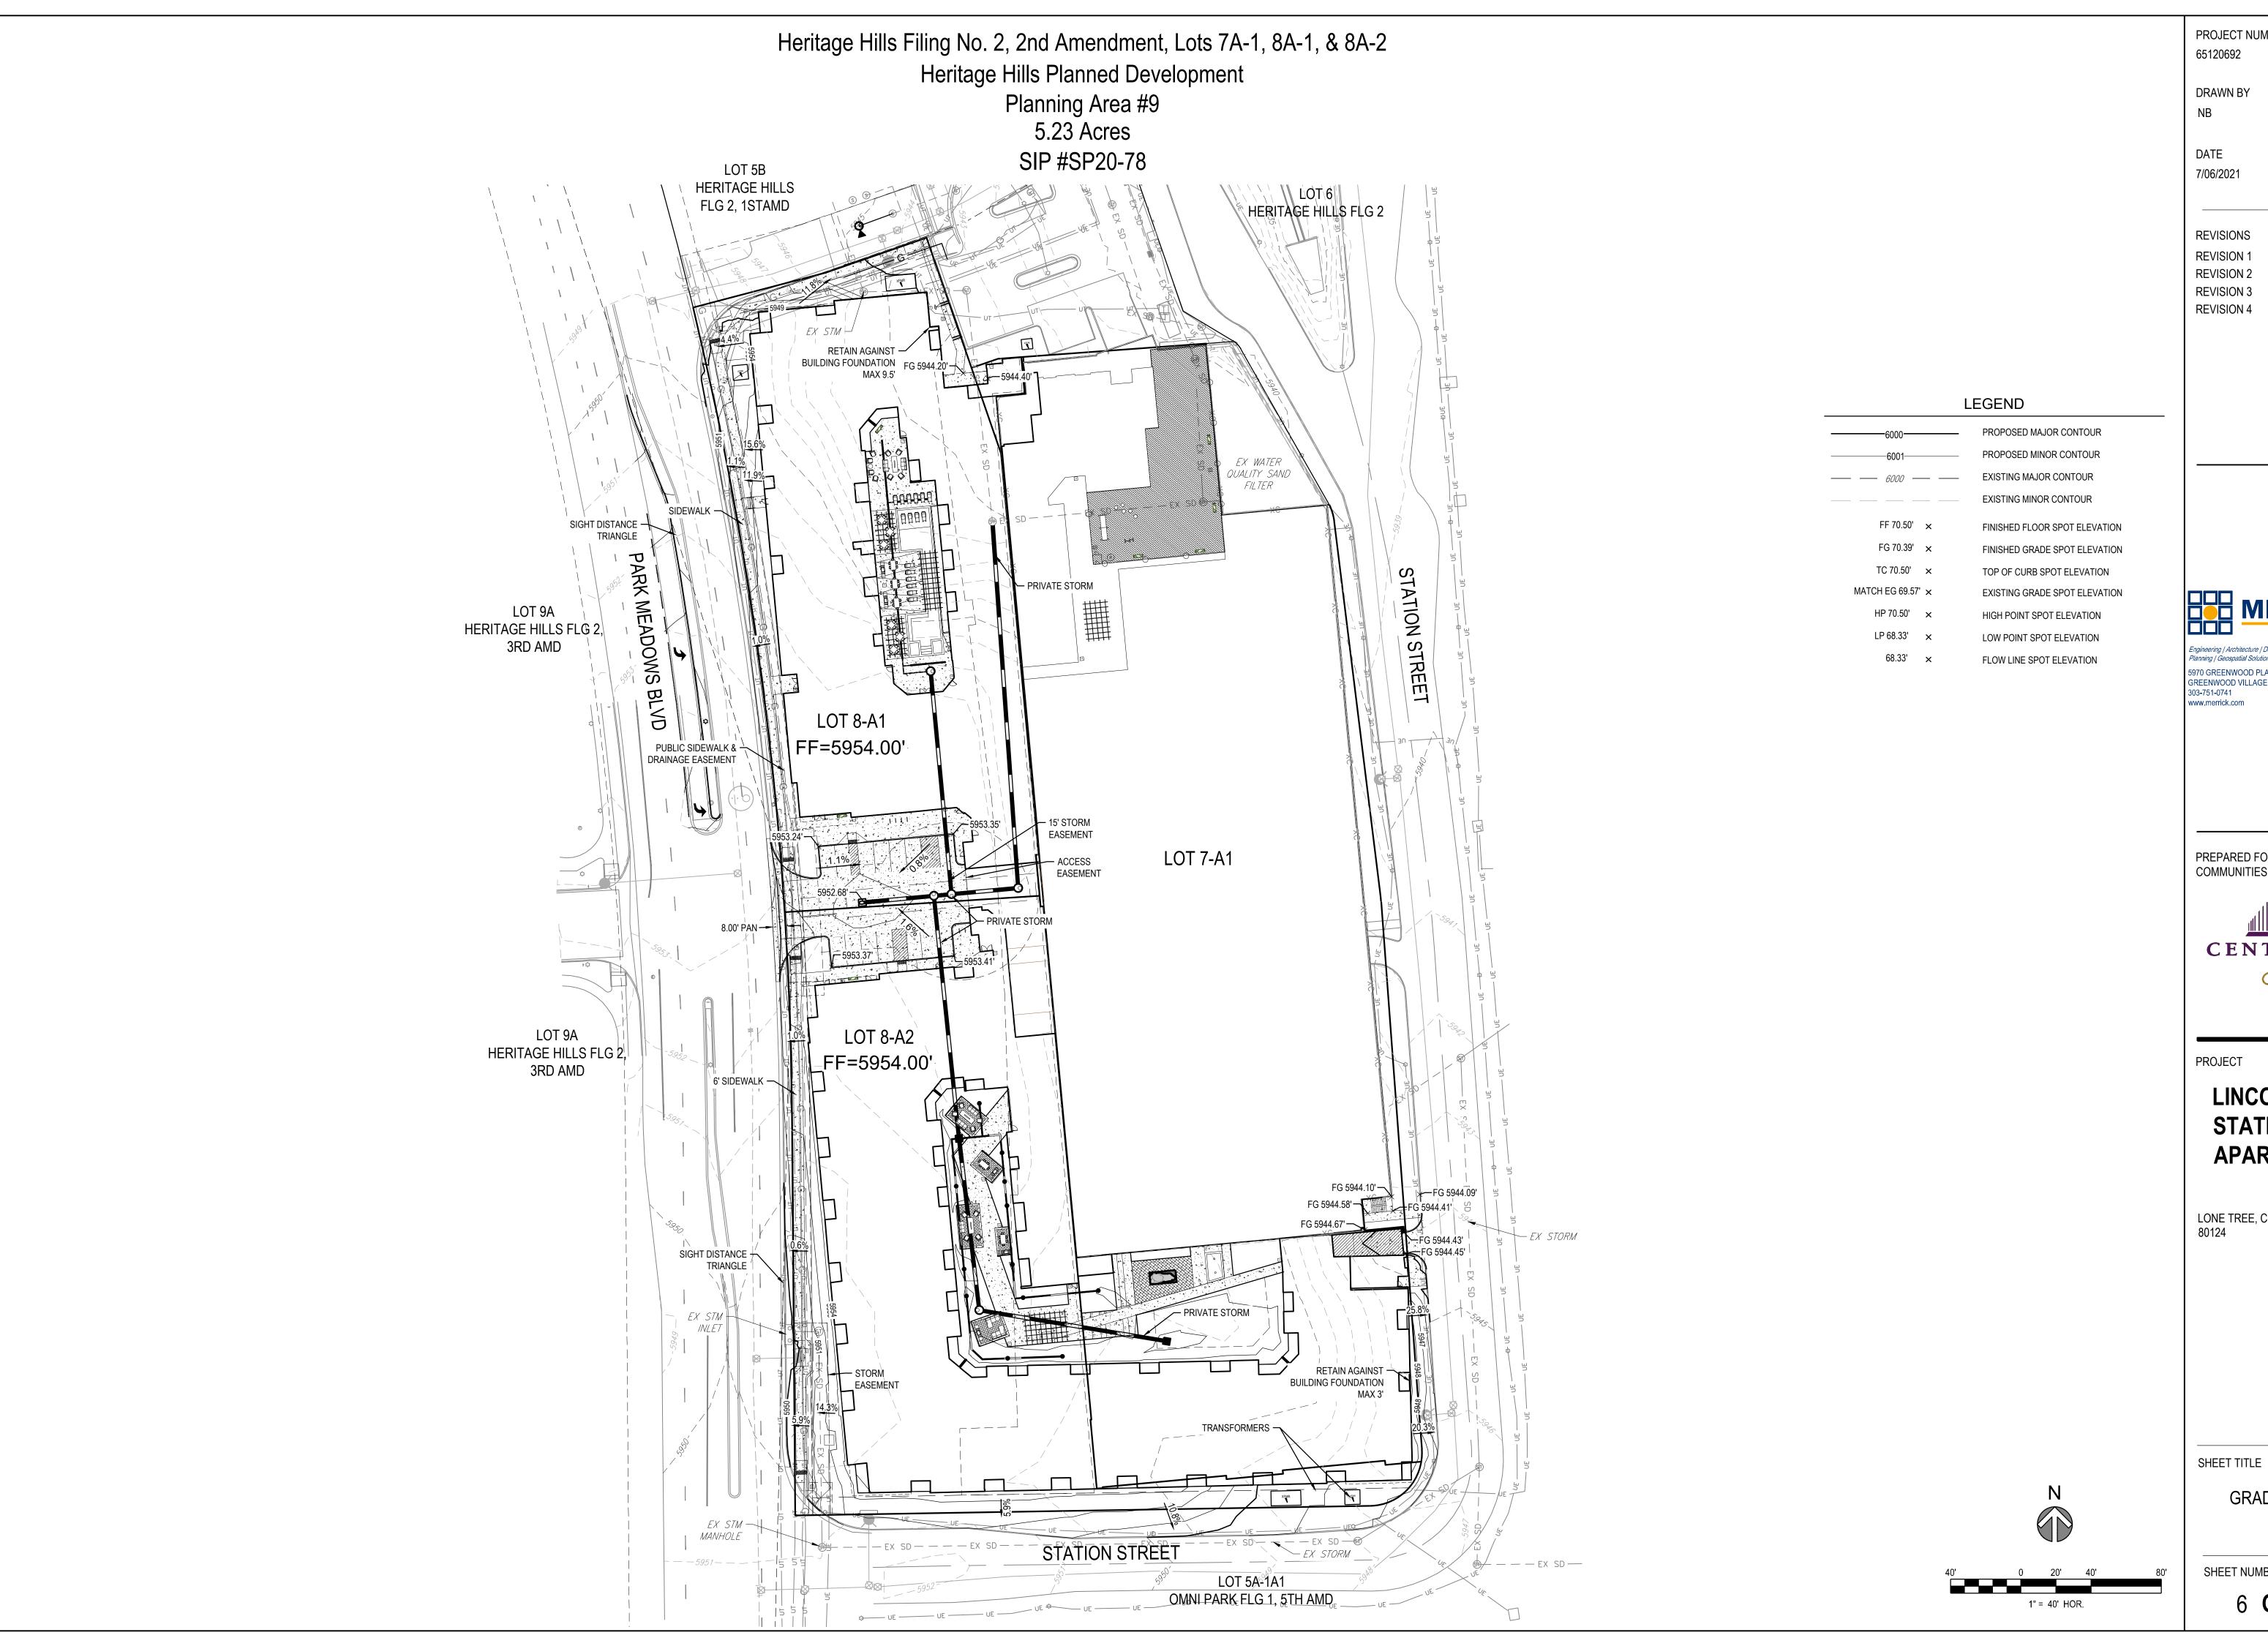

PROJECT NUMBER

REVISION 1 FEB 10, 2021 REVISION 2 MAR 16, 2021 REVISION 3 JUNE 10, 2021 REVISION 4 JULY 6, 2021

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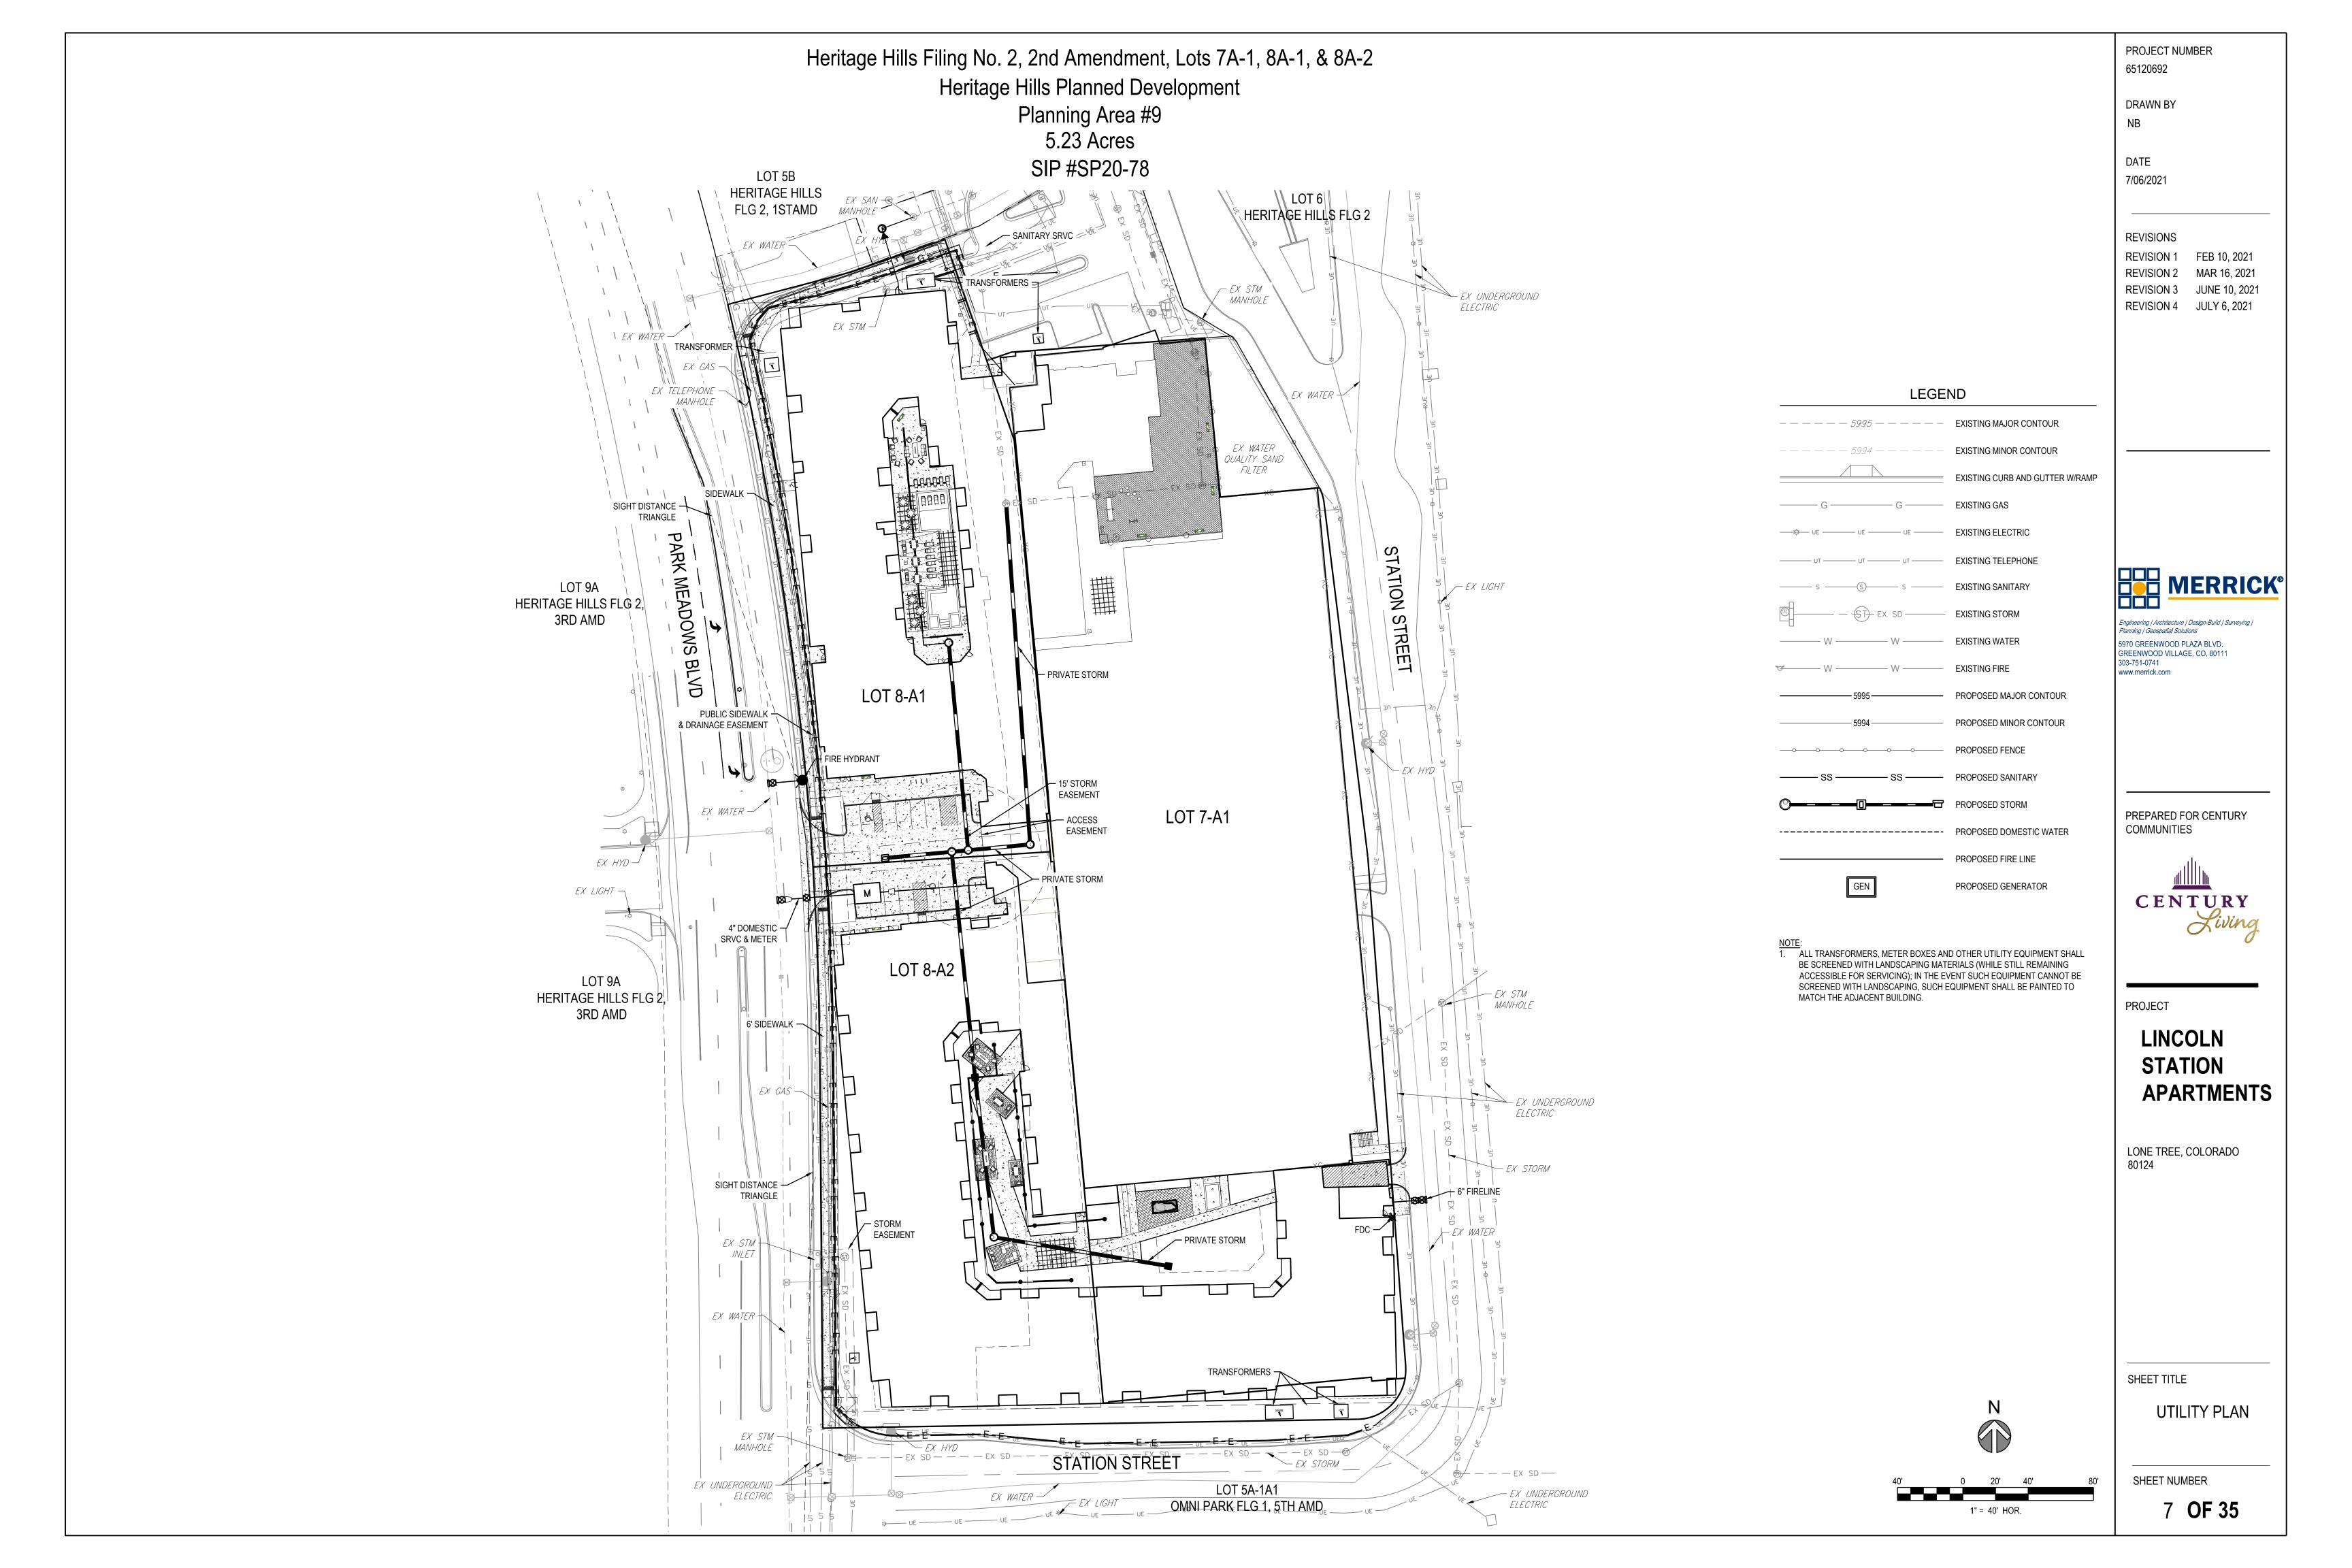



LINCOLN **STATION APARTMENTS**

LONE TREE, COLORADO

GRADING PLAN

SHEET NUMBER



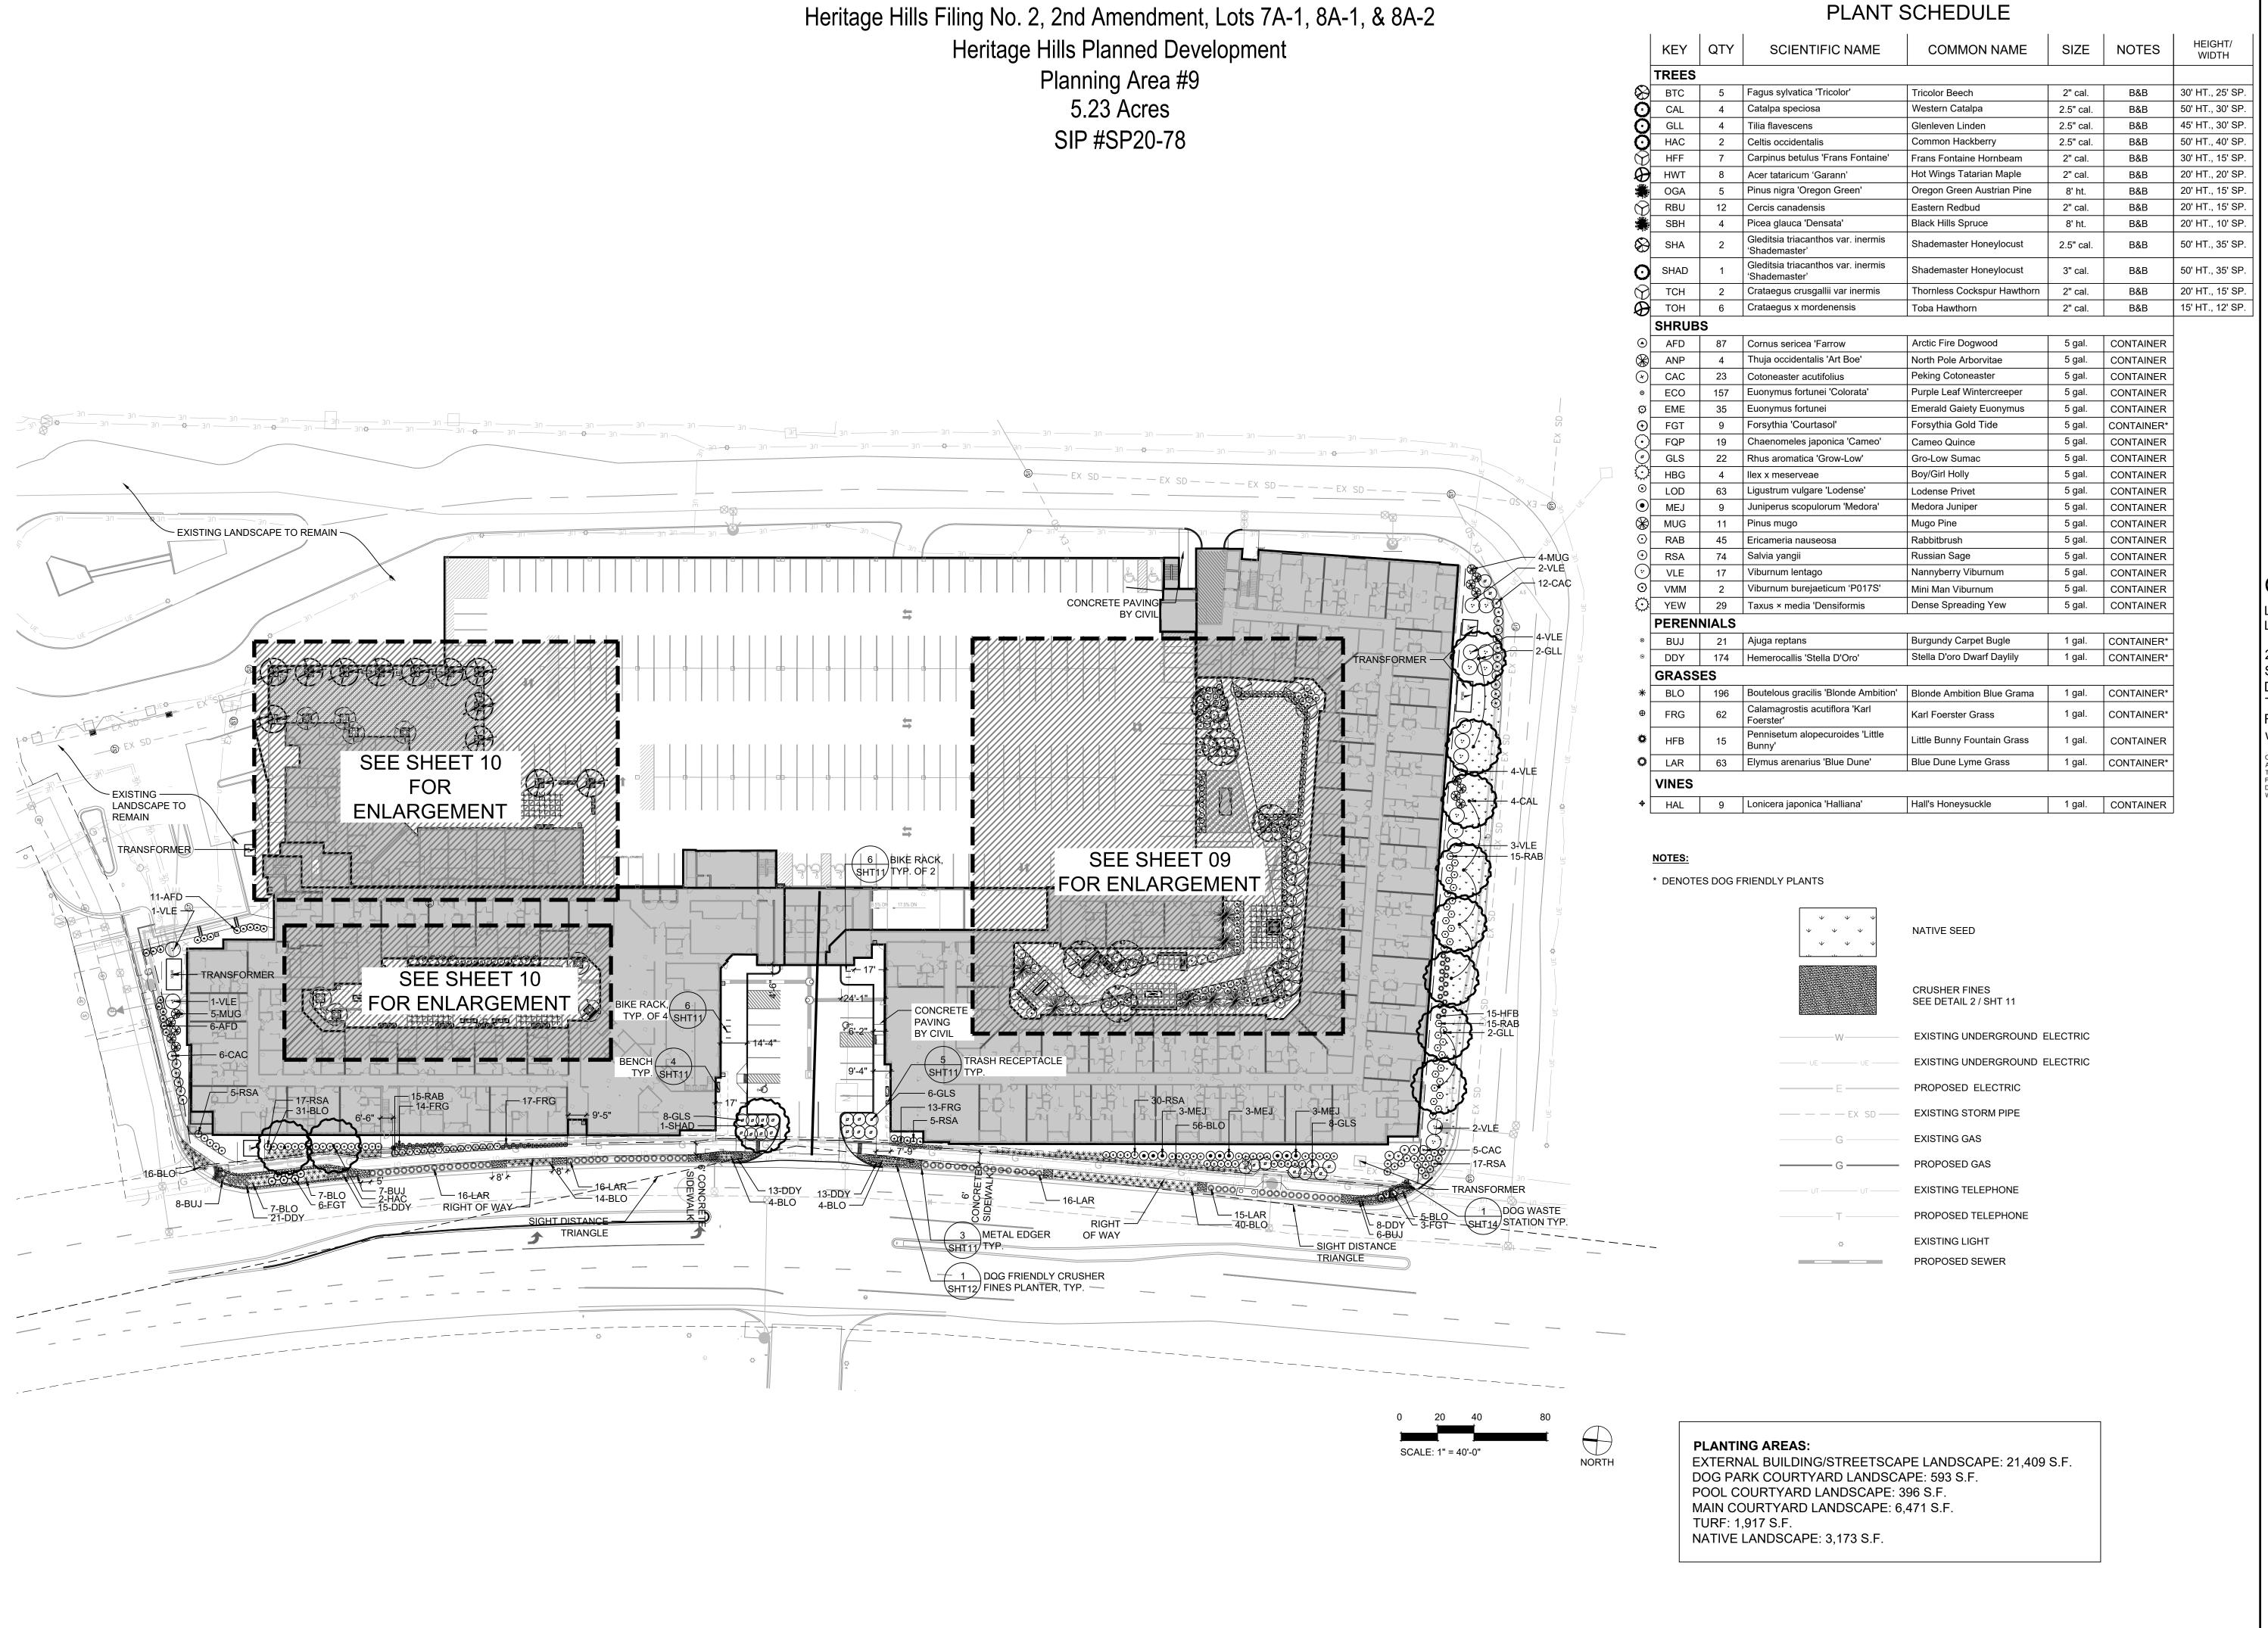

PROJECT NUMBER 65120692

DRAWN BY

DRAWN BY KW, RM, MLH

DATE 07/23/2021

REVISIONS
REVISION 1

REVISION 1 FEB 10, 2021 REVISION 2 MAR 16, 2021 REVISION 3 JUNE 10, 2021 REVISION 4 JULY 06, 2021 REVISION 5 JULY 23, 2021



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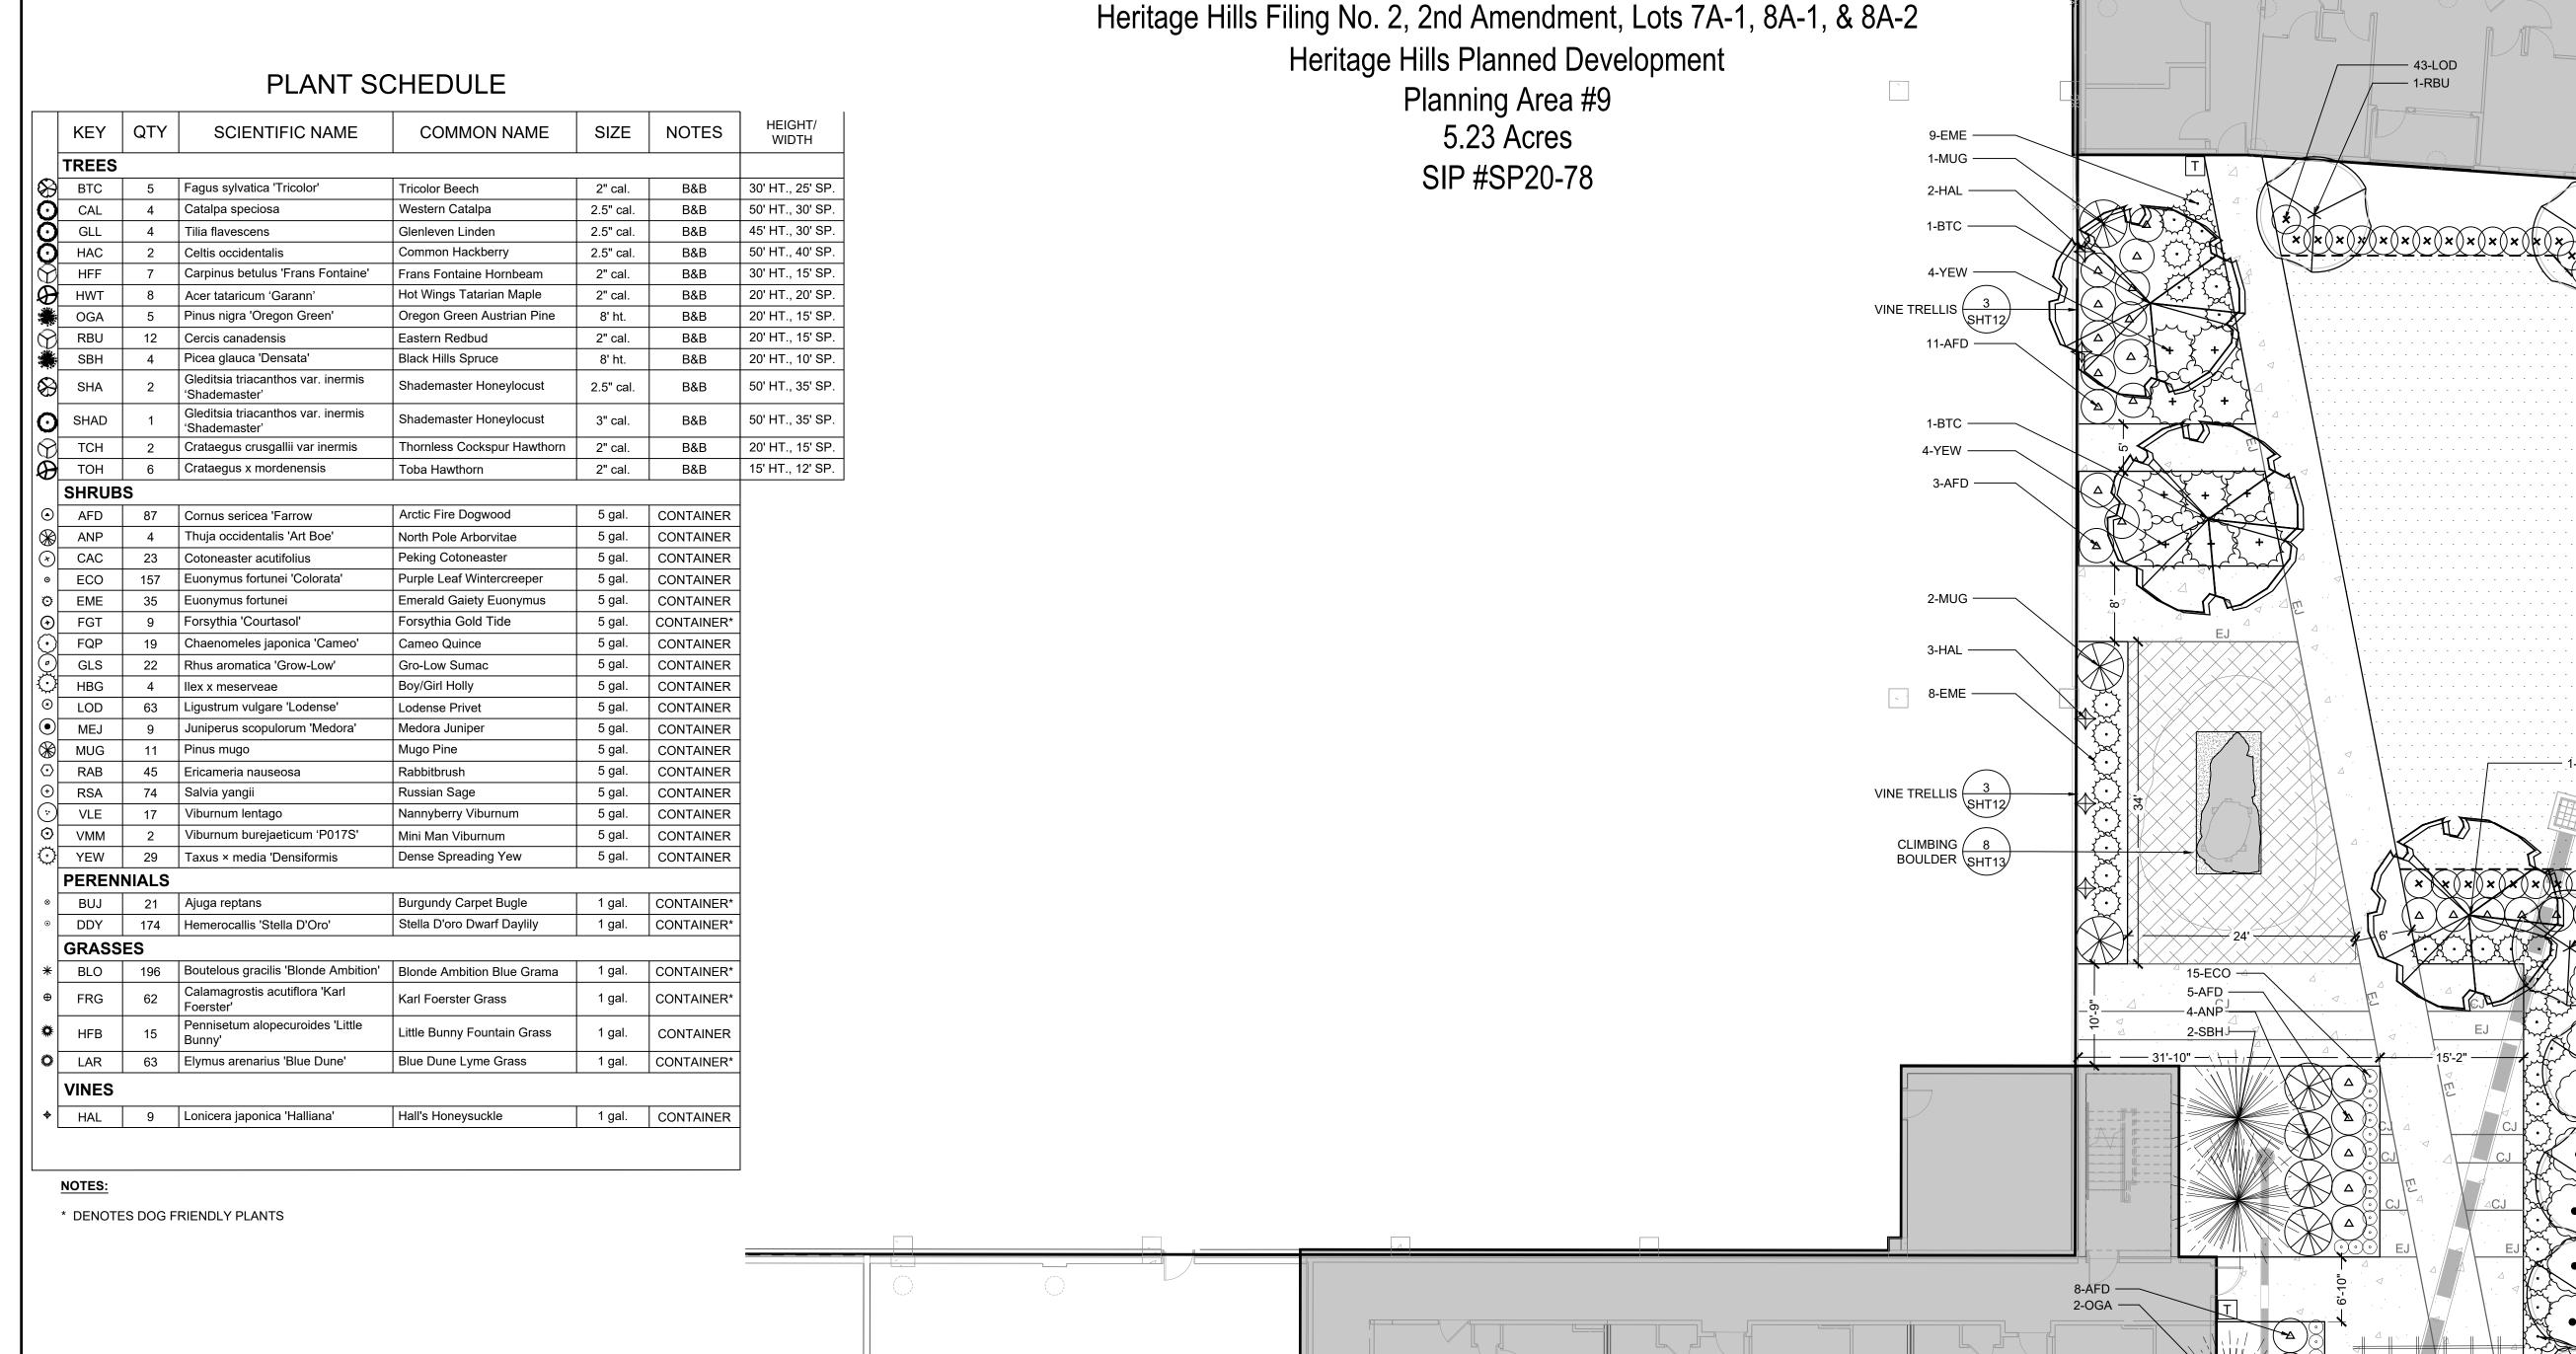
PROJECT

LINCOLN STATION APARTMENTS

LONE TREE, COLORADO 80124

OVERALL
LANDSCAPE
PLAN

SHEET NUMBER



1-SBH -3-YEW -

SAFIG SELSTATION SPLOWWALL STOP SPLOWWALL STOP SPLOWWALL SPECED SPAFIG SPLOW SAFIG SPECIAL SPAFIG SPA

19-AFD —

PROJECT NUMBER 65120692

DRAWN BY KW, RM, MLH

DATE 07/23/2021

REVISIONS

3 SHT11 METAL EDGER REVISIONS

REVISION 1 FEB 10, 2021

REVISION 2 MAR 16, 2021

REVISION 3 JUNE 10, 2021

REVISION 4 JULY 06, 2021

REVISION 5 JULY 23, 2021



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PROJECT

LINCOLN
STATION
APARTMENTS

LONE TREE, COLORADO

LANDSCAPE ENLARGEMENTS

SHEET NUMBER

SCALE: 1" = 10'-0"

NORTH

09 OF 35

SOD

PORCELAIN PAVERS SEE DETAIL 1/SHT11

SEE CIVIL

SAND FINISHED CONCRETE COLOR: TBD

FIBARPIP PLAY SURFACING REFER TO MANUFACTURERS SPECIFICATIONS FOR INSTALLATION

SAW CUT CONTROL JOINT

TRASH RECEPTACLE SEE DETAIL 5/SHT10

EXISTING UNDERGROUND ELECTRIC

EXISTING UNDERGROUND ELECTRIC

PROPOSED ELECTRIC


EXISTING STORM PIPE

EXISTING GASPROPOSED GAS

PROPOSED SEWER

EXISTING TELEPHONE
PROPOSED TELEPHONE

1 MAIN COURTYARD

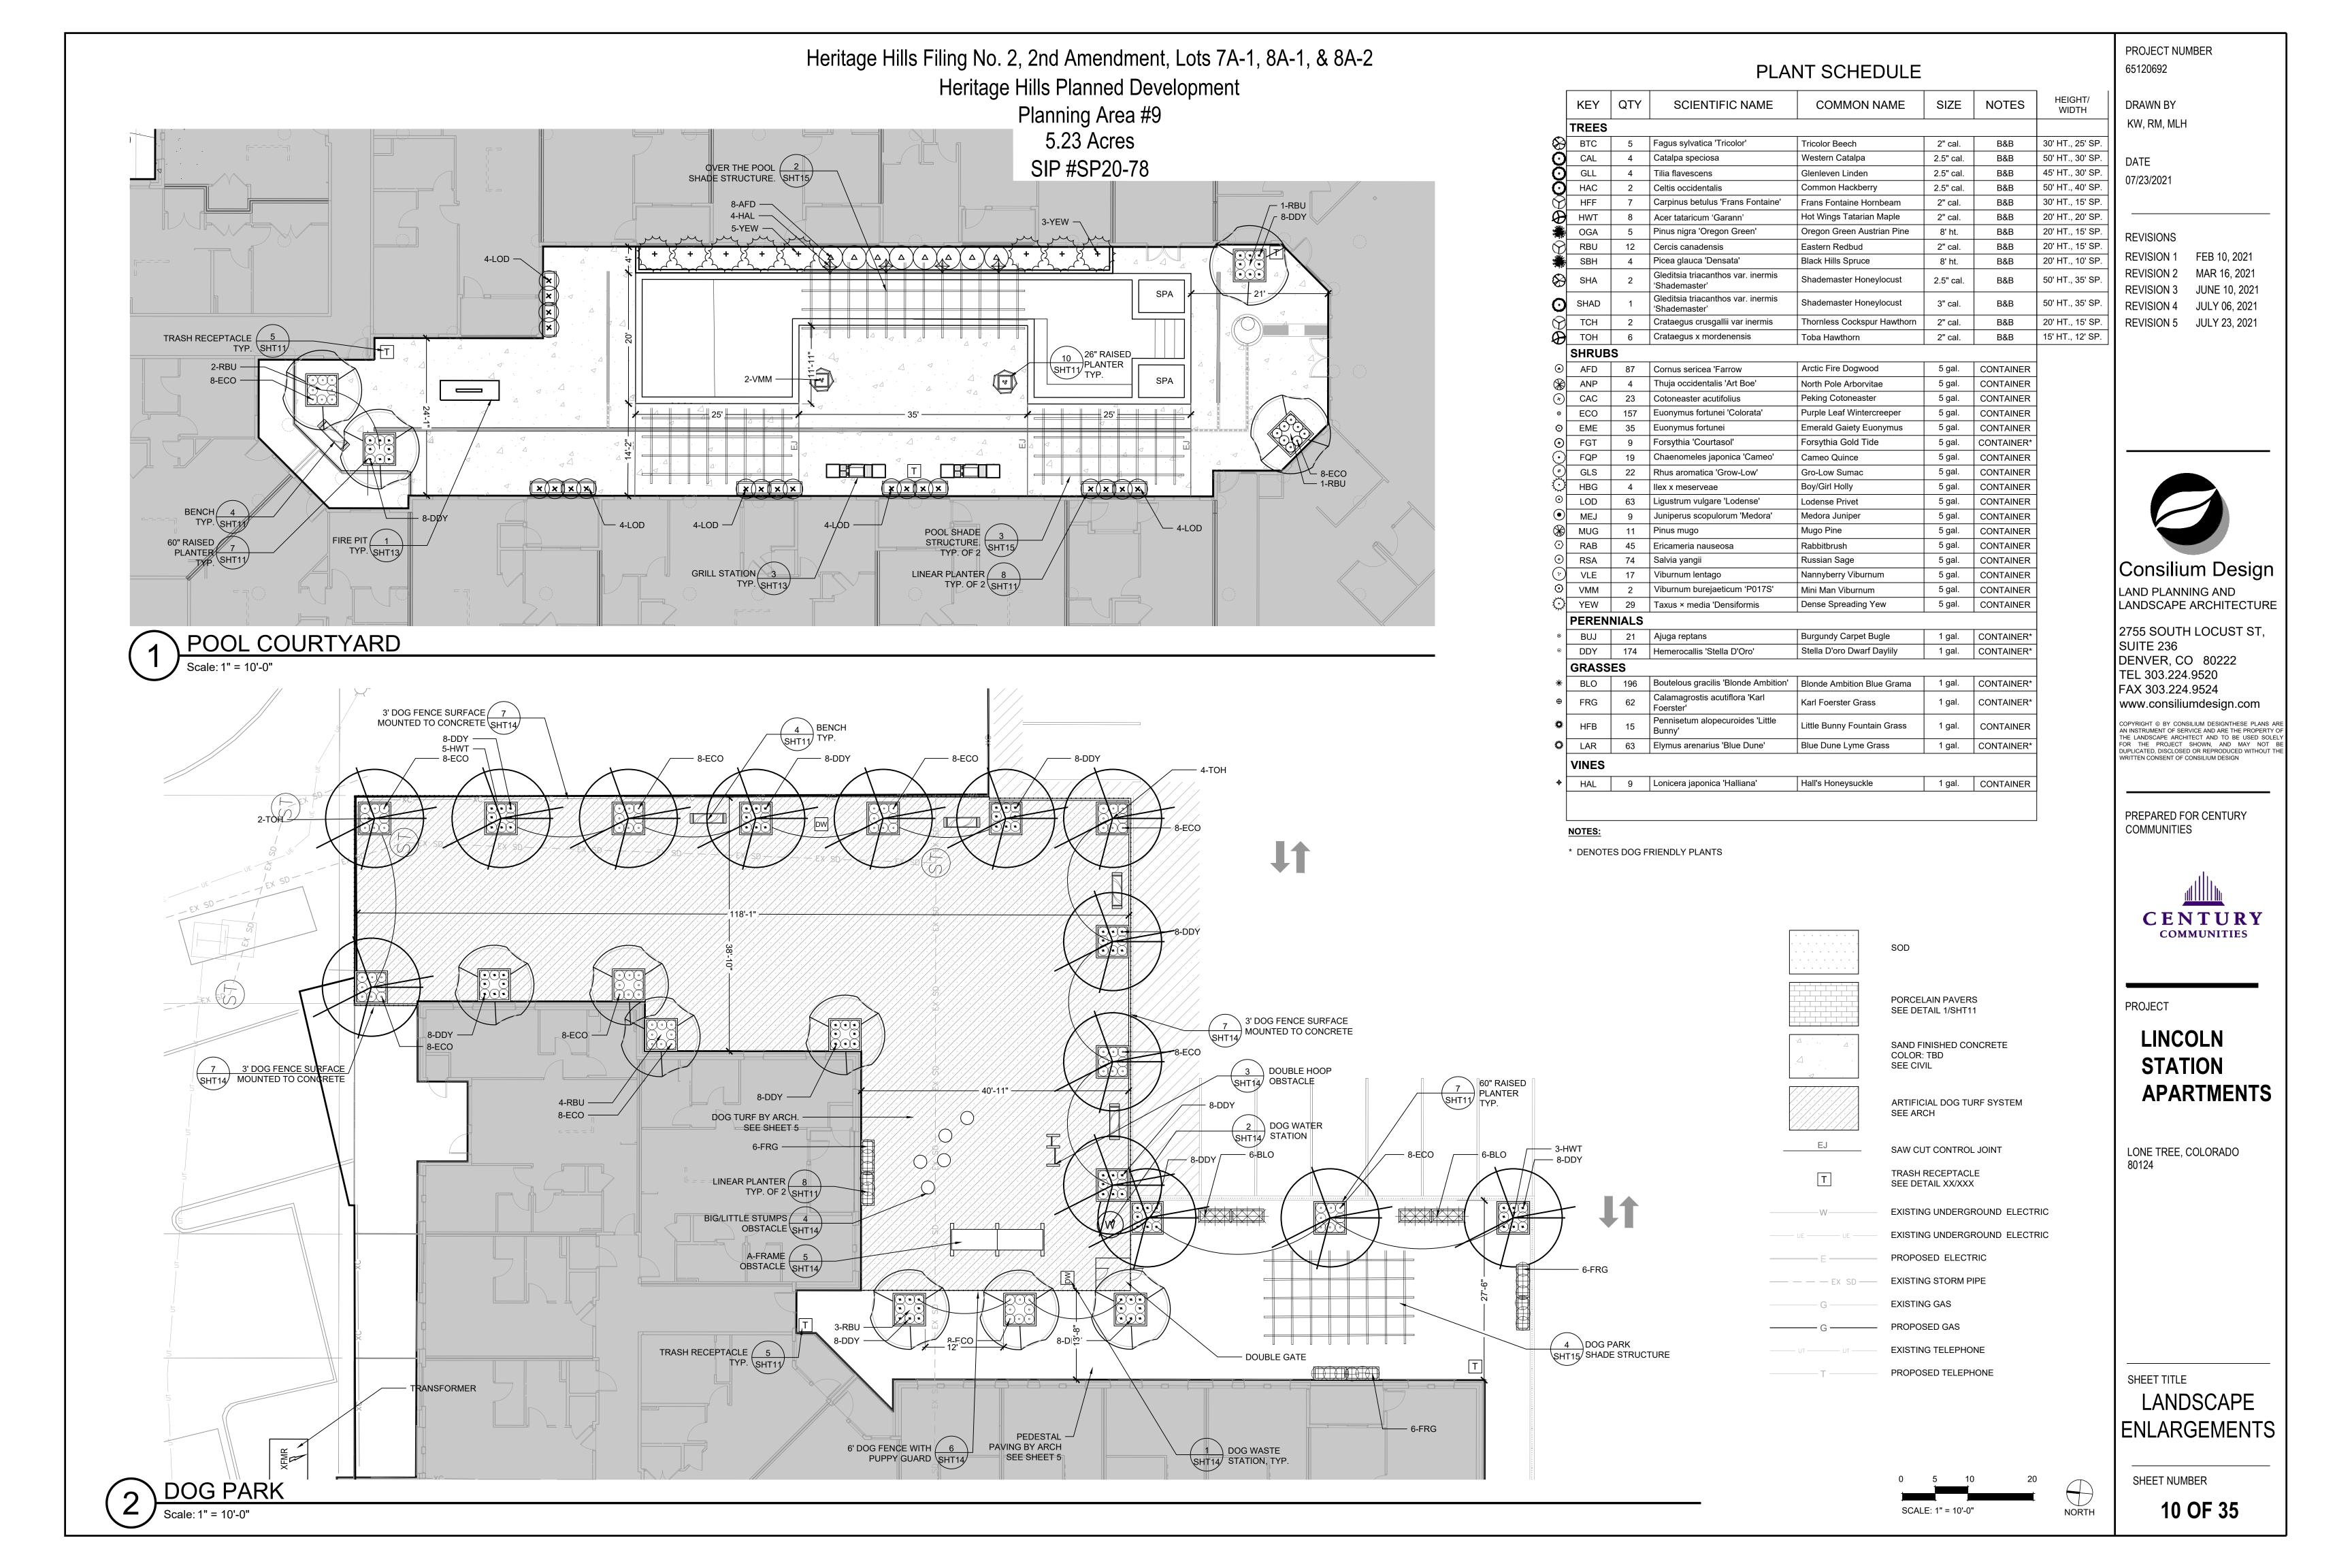



PORCELAIN PAVERS

PRODUCT: MOOD WOOD COLOR: HONEY SIZE: 12"X48" MANUFACTURER: MILESTONE TILE WEBSITE: WWW.MILESTONETILES.COM

> 7800 E. MICHIGAN AVE. KALAMAZOO, MI 49048

INFO: PRODUCT: SIT BENCH

TYPE: BACKED

COMPLIANT.

PLANTERS UNLIMITED

• SKU: F1-MOD-S6048

• SIZES: 60in.L x 60in.W x 48in.H

INSULATION FOR PLANTERS.

COLOR: METALLIC SILVER

W:WWW.PLANTERSUNLIMITED.COM

E: SALES@PLANTERSUNLIMITED.COM

PRODUCT: MODERN FIBERGLASS COMMERCIAL PLANTERS

 DRAINAGE: CONTRACTOR TO PROVIDE PROPER PLANTER DRAINAGE INTO PEDESTAL PAVER DRAINAGE SYSTEM.

INSULATION: CONTRACTOR TO PROVIDE PROPER

• INSTALLATION: INSTALL PER MANUFACTURERS

P: 1.888.320.0626

FINISH: METALLIC COLOR: SILVER

W. WWW.LANDSCAPEFORMS.COM

SIZE: 25" D. X 74"W. X 32"HEIGHT

MANUFACTURERS SPECIFICATIONS


NOTE: PER A117.1 SEC. 903, BENCH IS ADA

INSTALLATION: INSTALL PER

E: SPECIFY@LANDSCAPEFORMS.COM

Heritage Hills Filing No. 2, 2nd Amendment, Lots 7A-1, 8A-1, & 8A-2 Heritage Hills Planned Development

Planning Area #9 5.23 Acres

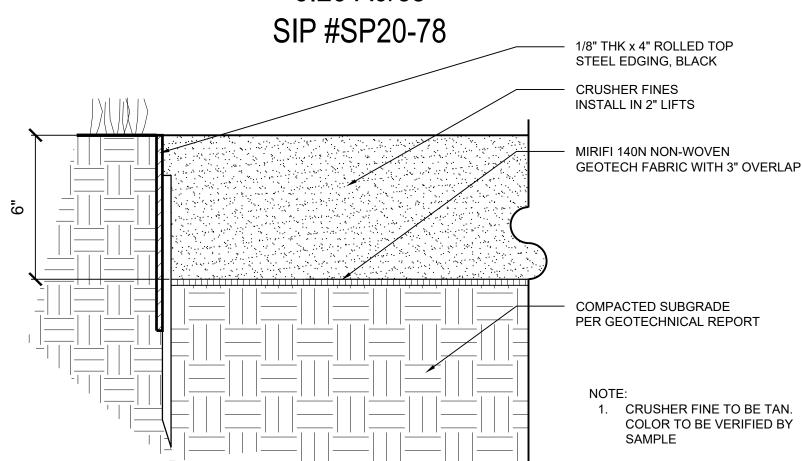

TOP OF EDGER, FLUSH WITH ADJACENT CONDITIONS UNLESS OTHERWISE NOTED 1/8" THK x 4" ROLLED TOP STEEL EDGING, BLACK TAPERED STAKE

> HANDLE WITH CARE! Bola's finish can be scuffed by contact with tools, concrete, or other abrasive surfaces. Protect the finish from damage during installation. Use touch-up paint to repair any powder coat finish abrasions.

with water, scrubbing, and removing excess water.

Wipe away any excess before it cures.

. Core drill 3" diameter (minimum) holes 6" deep. Prepare the holes for outdoor anchoring cement, such as Kwixset ™ or Super

Por-rok *. Follow the manufacturer's instructions for blowing out dust, filling

LANDSCAPE FORMS

P: 269.381.0396

Page 1 of 1

7800 E. MICHIGAN AVE.

KALAMAZOO, MI 49048

W: WWW.LANDSCAPEFORMS.COM E: SPECIFY@LANDSCAPEFORMS.COM

INFO:PRODUCT: BOLA BIKE RACK

SIZE: 1.5"D.X28.25"W.X32"W.INSTALLATION: SURFACE

MOUNTED, INSTALL PER

COLOR/FINISH: ELECTRO POLISHED

MANUFACTURERS SPECIFICATIONS

Place the bike rack back into position and fill the holes with anchoring

INSTALLATION:

METAL EDGER

Recommended spacing, according to Association of

9 26" RAISED PLANTER

Scale: NTS

Pedestrian and Bicycle Professionals (APBP)

Tools Required

· Unit ships assembled

PROJECT NUMBER 65120692

DRAWN BY KW, RM, MLH

DATE 07/23/2021

REVISIONS

REVISION 1 FEB 10, 2021 REVISION 2 MAR 16, 2021 REVISION 3 JUNE 10, 2021 JULY 06, 2021 **REVISION 4** REVISION 5 JULY 23, 2021

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LINCOLN **STATION**

- PRODUCT: MODERN FIBERGLASS COMMERCIAL PLANTERS SKU: F1-MOD-S2424
- SIZE: 26in.L x 26in.W x 30in.H

PLANTERS UNLIMITED P: 1.888.320.0626

COLOR: METALLIC SILVER

W:WWW.PLANTERSUNLIMITED.COM

E: SALES@PLANTERSUNLIMITED.COM

- INSTALLATION: INSTALL PER MANUFACTURERS
- SPECIFICATIONS. DRAINAGE: CONTRACTOR TO PROVIDE PROPER PLANTER
- DRAINAGE INTO PEDESTAL PAVER DRAINAGE SYSTEM. INSULATION: CONTRACTOR TO PROVIDE PROPER

INSULATION FOR PLANTERS.

LAND PLANNING AND LANDSCAPE ARCHITECTURE

FAX 303.224.9524

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PROJECT

APARTMENTS

LONE TREE, COLORADO

FURNISHINGS

PLAN

SHEET NUMBER

11 OF 35

CRUSHER FINES PAVING



TRASH RECEPTACLE



PLANTERS UNLIMITED P: 1.888.320.0626 W:WWW.PLANTERSUNLIMITED.COM E: SALES@PLANTERSUNLIMITED.COM

 PRODUCT: MODERN FIBERGLASS RECTANGULAR PLANTER SKU: F1-MOD-REC602424

 SIZES: 60in.L x 24in.W x 24in.H COLOR: METALLIC SILVER

INSTALLATION: INSTALL PER MANUFACTURERS

DRAINAGE: CONTRACTOR TO PROVIDE PROPER PLANTER DRAINAGE INTO PEDESTAL PAVER DRAINAGE SYSTEM.


INSULATION: CONTRACTOR TO PROVIDE PROPER INSULATION


60" RAISED PLANTER

LINEAR PLANTER

Heritage Hills Filing No. 2, 2nd Amendment, Lots 7A-1, 8A-1, & 8A-2 Heritage Hills Planned Development

Planning Area #9 5.23 Acres SIP #SP20-78

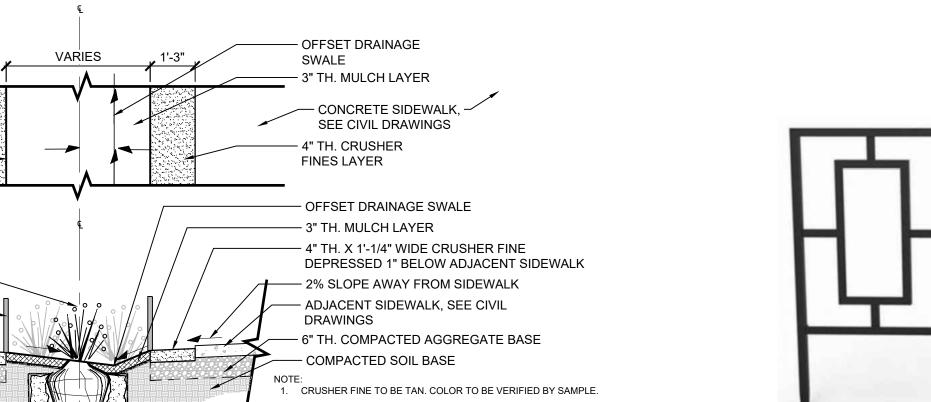

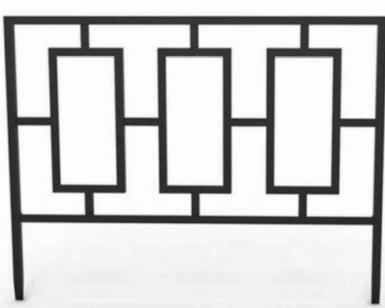


PRODUCT: 84575 CONTEMPORARY STYLE GARDEN BORDER EDGE SIZE: 14"(H) X 18"(W) MANUFACTURER: PANACEA™ WEBSITE: WWW.TOOLBOXSUPPLY.COM

1 DOG FRIENDLY CRUSHER FINES PLANTER

PLANTER GUARD

Scale: NTS

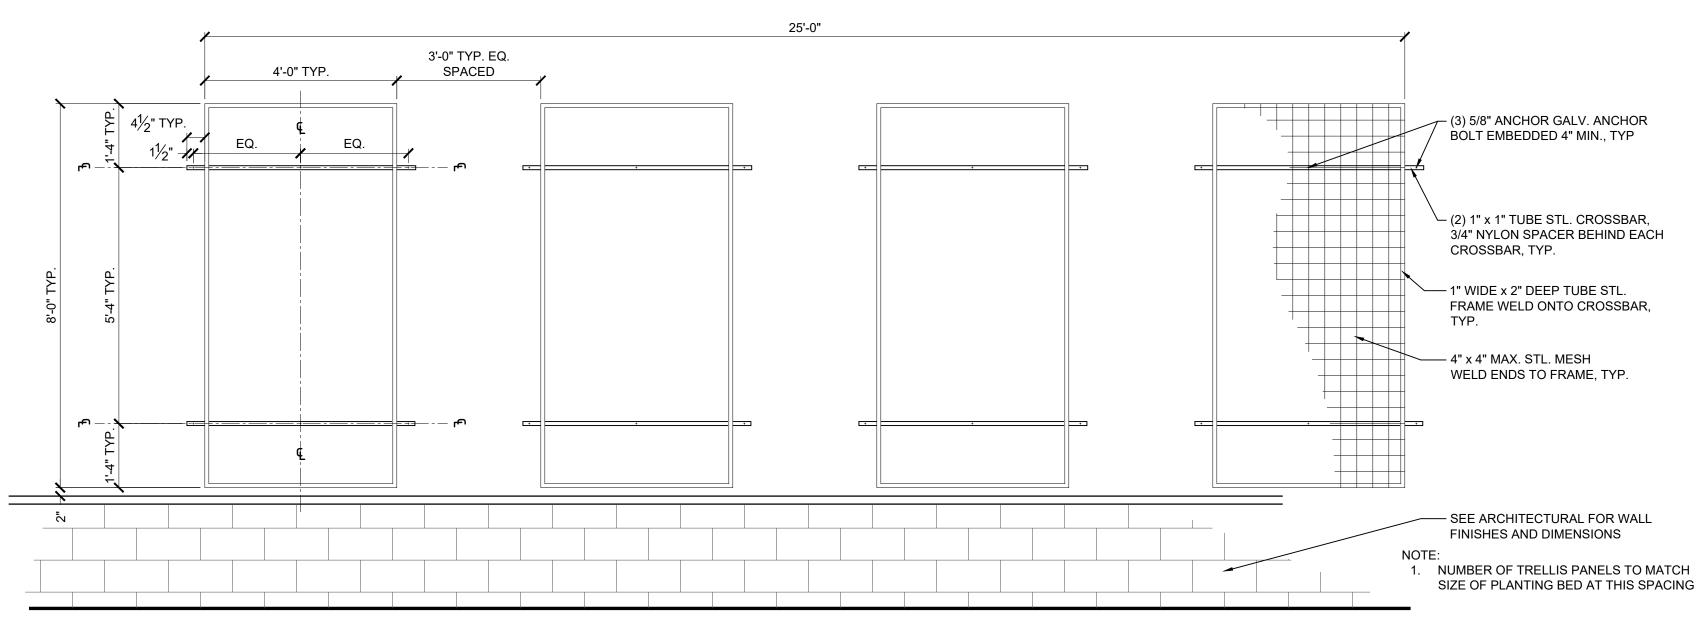

VINE TRELLIS

CURB AND GUTTER, -SEE CIVIL DRAWINGS

PLANTING -

2% SLOPE AWAY FROM CURB -

PROJECT NUMBER 65120692

DRAWN BY KW, RM, MLH

DATE 07/23/2021

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Consilium Design
LAND PLANNING AND
LANDSCAPE ARCHITECTURE

2755 SOUTH LOCUST ST, SUITE 236 DENVER, CO 80222 TEL 303.224.9520 FAX 303.224.9524 www.consiliumdesign.com

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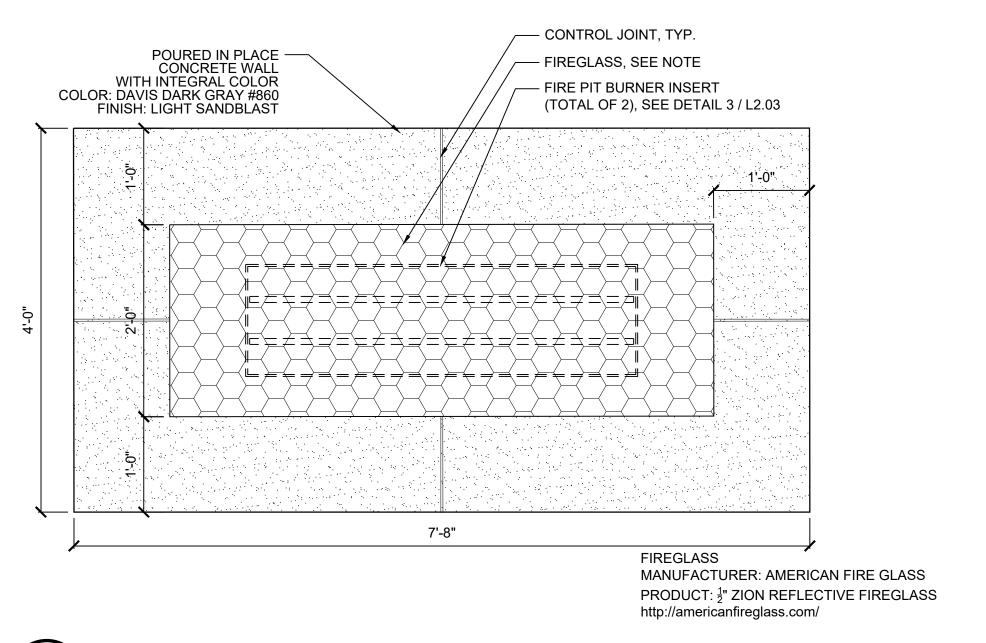
PROJECT

LINCOLN STATION APARTMENTS

LONE TREE, COLORADO 80124

SHEET TITLE
SITE
FURNISHINGS
PLAN

SHEET NUMBER



Heritage Hills Filing No. 2, 2nd Amendment, Lots 7A-1, 8A-1, & 8A-2 Heritage Hills Planned Development Planning Area #9 5.23 Acres SIP #SP20-78 FIREGLASS ----PIP CONCRETE WALL - REINFORCING PER STRUCTURAL DESIGN GAS PER - SEE PATIO DETAIL MECHANICAL ENGINEER CLASS II AGGREGATE **BLOCK OUT** COMPACT TO 95% FOR CONTROLS

- WEEP HOLES

MASONRY OR SYNTHETIC VENEER

1/2"x1/2" TS w/2"x2" WWM SAFETY

DRAWINGS FOR APPROVAL.

- OUTDOOR LIFESTYLES DAKOTA

OUTDOOR GAS FIREPLACE BY

TO MATCH BUILDING MASONRY (TYP.) SUBMIT SAMPLE FOR APPROVAL

SCREEN AT ALL FIREPLACE OPENINGS.

LOCKING MECHANISM AT ONE OPENING

(3 TOTAL) PROVIDE 3 HINGES AND 1

FOR MAINTENANCE. PROVIDE SHOP


HEARTH AND HOME TECHNOLOGIES

PRECAST / POURED IN PLACE / OR STONE CAP (TO BE DETERMINED) (TYP.)

SUBMIT SAMPLE FOR APPROVAL

THREE SIDED FIREPLACE - ELEVATION


COMPACT TO 95%

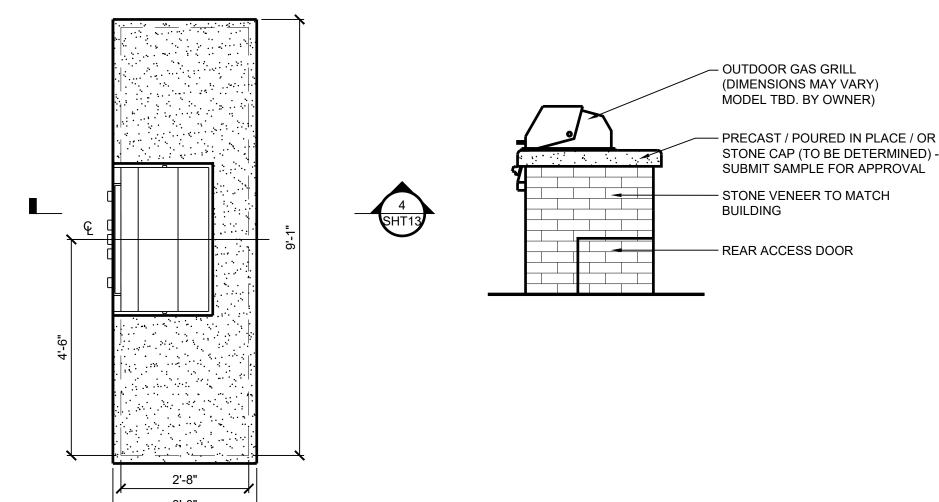

DRAWN BY KW, RM, MLH DATE 07/23/2021 **REVISIONS REVISION 1** FEB 10, 2021 **REVISION 2** MAR 16, 2021 **REVISION 3** JUNE 10, 2021 **REVISION 4** JULY 06, 2021 REVISION 5 JULY 23, 2021

PROJECT NUMBER

65120692

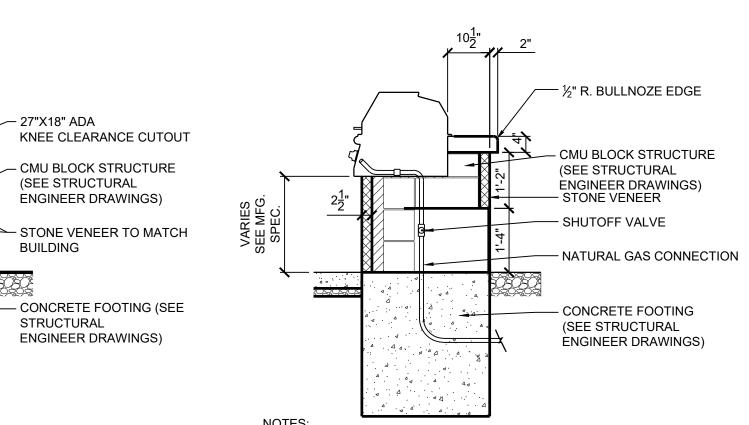

1. INSTALL PER MANUFACTURER'S RECOMMENDATIONS 2. STONE TYPE, PATTERN, & COLOR TO BE DETERMINED BY OWNER 3. ALL STRUCTURAL DESIGN AND DETAILING PER CONSTRUCTION

FIRE PIT: SECTION

FRONT/SIDE


BURNER

TYPICAL OF 2

ELECTRICAL PER

ELECTRICAL ENGINEER



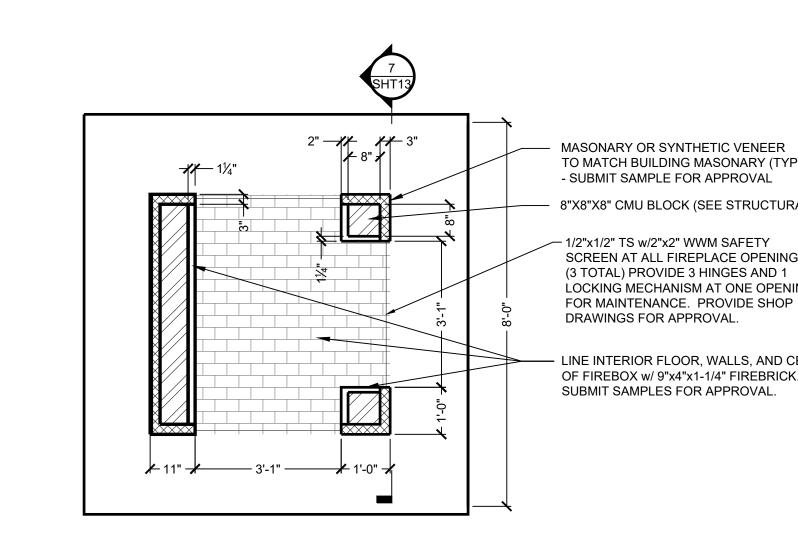

MASONARY OR SYNTHETIC VENEER TO MATCH BUILDING MASONARY (TYP.) - SUBMIT SAMPLE FOR APPROVAL 8"X8"X8" CMU BLOCK (SEE STRUCTURAL)

- 1/2"x1/2" TS w/2"x2" WWM SAFETY SCREEN AT ALL FIREPLACE OPENINGS (3 TOTAL) PROVIDE 3 HINGES AND 1 LOCKING MECHANISM AT ONE OPENING

 LINE INTERIOR FLOOR, WALLS, AND CEILING PREPARED FOR CENTURY OF FIREBOX w/ 9"x4"x1-1/4" FIREBRICK. SUBMIT SAMPLES FOR APPROVAL. COMMUNITIES

> **CENTURY COMMUNITIES**

LINCOLN

STATION

LONE TREE, COLORADO

APARTMENTS

PROJECT

Consilium Design

LANDSCAPE ARCHITECTURE

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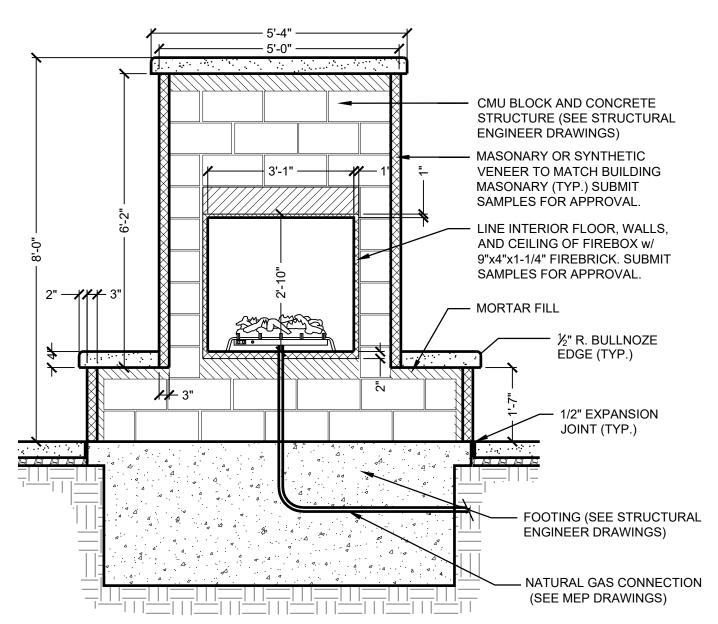
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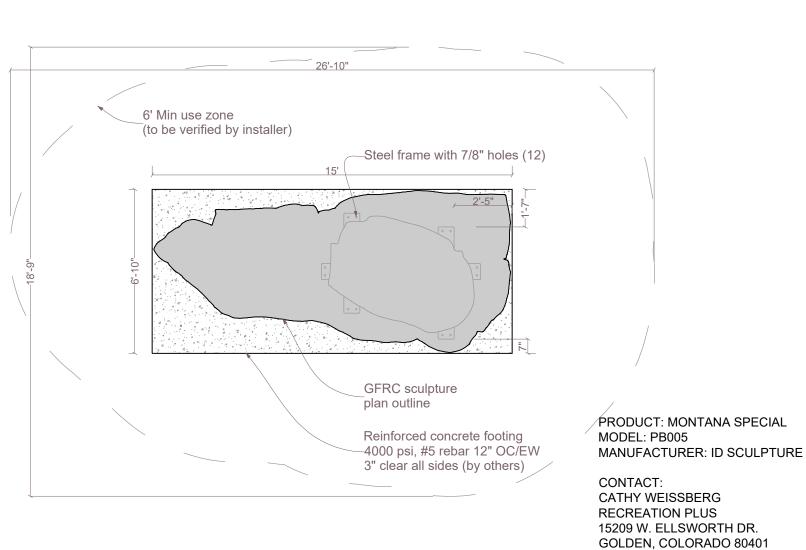
SUITE 236


THREE SIDED FIREPLACE - SECTION A

Scale: 1/2" = 1'-0"

GRILL STATION-SECTION Scale: 1/2" = 1'-0"





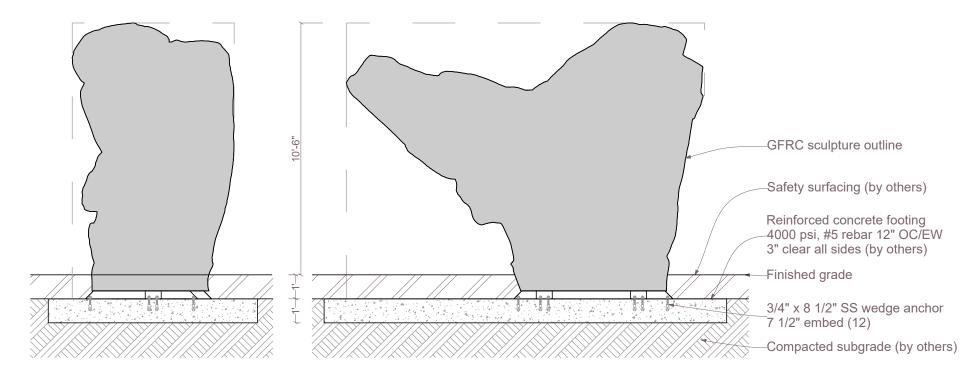

CLIMBING BOULDER - PLAN

CLIMBING BOULDER - ELEVATION

Scale: NTS

SHEET TITLE SITE **FURNISHINGS** PLAN

SHEET NUMBER

13 OF 35

27"X18" ADA

BUILDING

THREE SIDED FIREPLACE - SECTION B

BACK

1. INSTALL PER MANUFACTURER'S RECOMMENDATIONS

2. STONE TYPE, PATTERN, & COLOR TO BE DETERMINED BY OWNER 3. ALL STRUCTURAL DESIGN AND DETAILING PER CONSTRUCTION





DOGIPOT 5340 YOUNG PINE RD., SUITE 8 ORLANDO, FL 32829 P: 800.364.7681 W: WWW.DOGIPOT.COM E: INFO@DOGIPOT.COM

PRODUCT: ALUMINUM HEAD PAK DOGIPOT PET STATION PRODUCT NUMBER: #1003HP-L SIZE: 2"X2"X4'-8'

INSTALLATION: INSTALL PER MANUFACTURERS SPECIFICATIONS.






DOG-ON-IT-PARKS 4818 EVERGREEN WAY, STE 250 EVERETT, WA 98203 P: 877-348-3647 W: WWW.DOG-ON-IT-PARKS.COM

INFO:
PRODUCT: LITTLE & BIG STUMP JUMPS

ND7110/ND7111 INSTALLATION: INSTALL PER MANUFACTURERS SPECIFICATIONS.



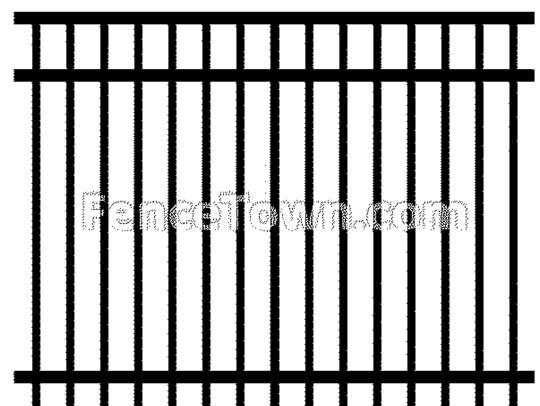

8465 WEST SAHARA AVE SUITE: 111-124 LAS VEGAS, NEVADA 89117 P: (888) 336-2386 W: WWW.FENCETOWN.COM/

PRODUCT: SPECRAIL SAYBROOK COMMERCIAL FENCE PANEL 36H POWDERCOATED BLACK SR-COM-SAYBROOK-36H

SURFACE MOUNT TO CONCRETE PER MANUFACTURER'S SPECIFICATIONS.



Heritage Hills Filing No. 2, 2nd Amendment, Lots 7A-1, 8A-1, & 8A-2 Heritage Hills Planned Development Planning Area #9



DOG-ON-IT-PARKS 4818 EVERGREEN WAY, STE 250 EVERETT, WA 98203 P: 877-348-3647 W: WWW.DOG-ON-IT-PARKS.COM

PRODUCT: 7214 DELUXE DOG WATERING STATION INSTALLATION: INSTALL PER MANUFACTURERS SPECIFICATIONS.



3 DOUBLE HOOP OBSTACLE

Scale: NTS

4818 EVERGREEN WAY, STE 250 EVERETT, WA 98203 P: 877-348-3647 W: WWW.DOG-ON-IT-PARKS.COM

INFO: PRODUCT: ECO DOUBLE HOOP JUMP R7609 INSTALLATION: INSTALL PER MANUFACTURERS SPECIFICATIONS.

DOG WATER STATION

(5) A-FRAME OBSTACLE

Scale: NITS



DOG-ON-IT-PARKS 4818 EVERGREEN WAY, STE 250 EVERETT, WA 98203 P: 877-348-3647 W: WWW.DOG-ON-IT-PARKS.COM

PRODUCT: ECO A-FRAME LARGE R7601 INSTALLATION: INSTALL PER MANUFACTURERS

8465 WEST SAHARA AVE SUITE: 111-124 LAS VEGAS, NEVADA 89117 P: (888) 336-2386

W: WWW.FENCETOWN.COM/

PRODUCT: SPECRAIL SAYBROOK COMMERCIAL FENCE PANEL 72H WITH PET PANEL POWDERCOATED BLACK SR-COM-SAYBROOK-72H

INSTALL INGROUND PER MANUFACTURER'S SPECIFICATIONS.

6' DOG FENCE WITH PUPPY GUARD



PROJECT NUMBER 65120692

DRAWN BY KW, RM, MLH

DATE

07/23/2021

REVISIONS

REVISION 1 FEB 10, 2021 REVISION 2 MAR 16, 2021 REVISION 3 JUNE 10, 2021 REVISION 4 JULY 06, 2021 REVISION 5 JULY 23, 2021



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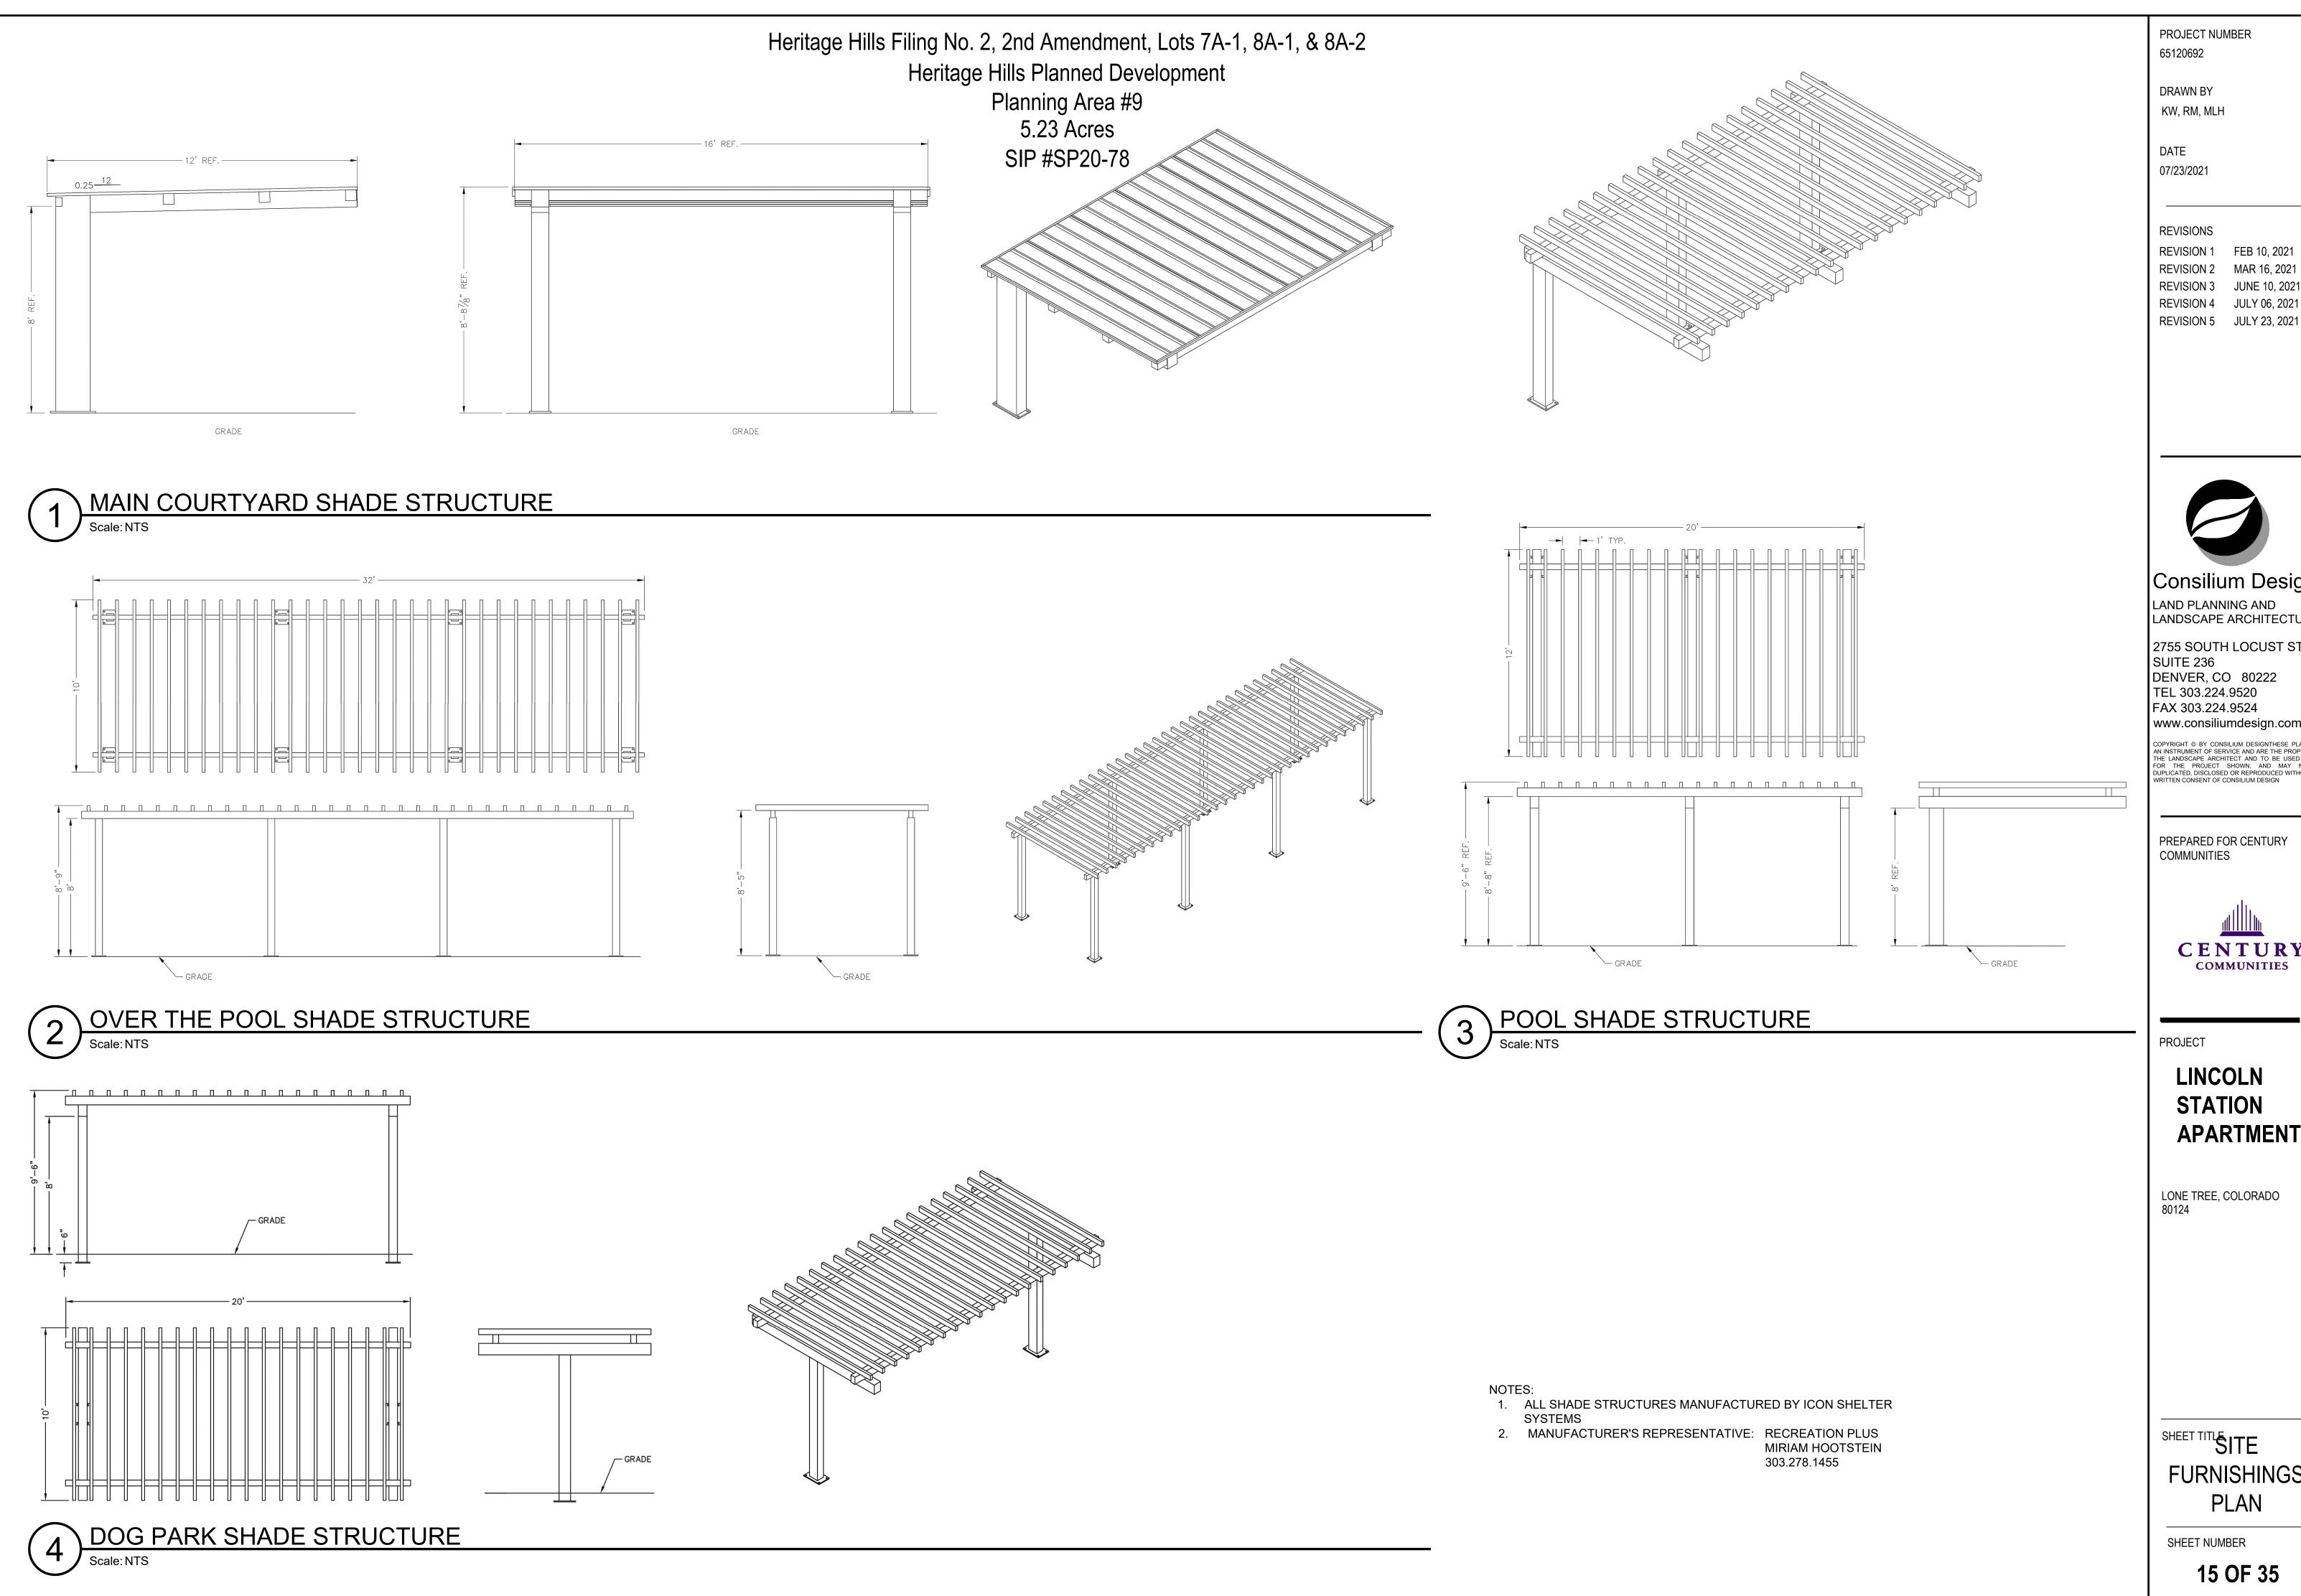
PROJECT

LINCOLN **STATION APARTMENTS**

LONE TREE, COLORADO

FURNISHINGS PLAN

SHEET NUMBER



PROJECT NUMBER

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LINCOLN **STATION APARTMENTS**

LONE TREE, COLORADO 80124

FURNISHINGS PLAN

SHEET NUMBER

PREVAILING WINDS DO NOT CUT CENTRAL LEADER - PRUNE ALL DEAD OR DAMAGED WOOD PRIOR TO PLANTING - 4" TREE WRAP (APPLY IN WINTER AFTER LEAVES DROP), REMOVE PER MAINTENANCE AGREEMENT WITH OWNER AT END OF EACH WIRE - PVC MARKERS TYP. / 12 GAUGE GALVANIZED WIRE - DRIVE TREATED WOOD POST 30" INTO UNDISTURBED GRADE, 2 PER TREE REMOVE POSTS 1 YEAR AFTER PLANTING _ SET TOP OF ROOTBALL 2" ABOVE FINISHED GRADE - 3" SHREDDED WOOD MULCH IN TREE WELL - REMOVE WIRE BASKET AFTER TREE IS IN PIT, REMOVE TWINE AND PULL BURLAP FROM TREE BROKEN OR DAMAGED ROOTBALLS

WILL BE REJECTED

1/2 SPECIFIED BACKFILL MIX & 1/2 PIT

FERTILIZER FOR NEW PLANTING

UNDISTURBED SUBGRADE


SOIL, USE ROOT STIMULATOR & RELEASE

Heritage Hills Filing No. 2, 2nd Amendment, Lots 7A-1, 8A-1, & 8A-2 Heritage Hills Planned Development

Planning Area #9 5.23 Acres

SIP #SP20-78

UNDISTURBED SUBGRADE

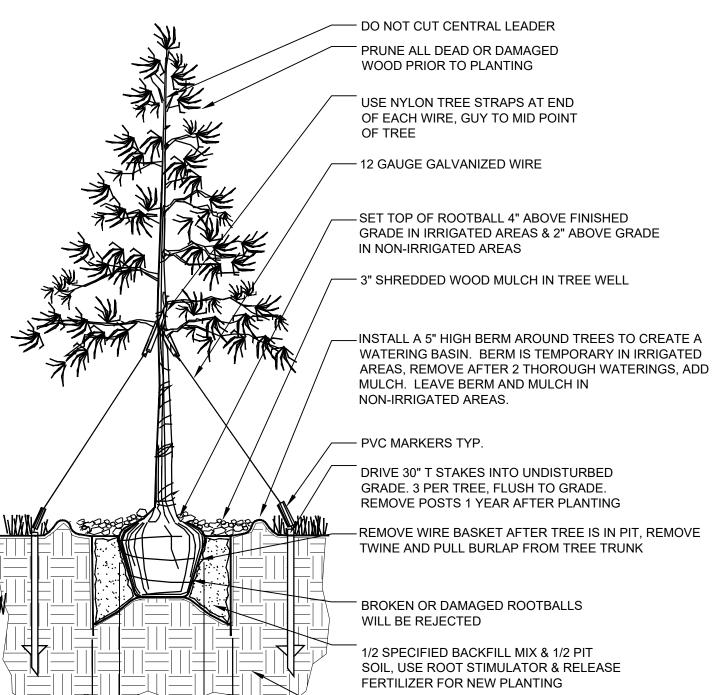

- SPACE PLANTS FOR BEST EFFECT - PRUNE DEAD OR DAMAGED WOOD PRIOR TO PLANTING - SET SHRUB PLUMB, TOP OF ROOTBALL MATCH FINISH GRADE, 2" ABOVE GRADE FOR EVERGREENS. - 3" DEEP SHREDDED WOOD MULCH. BUILD AS 4" BASIN IN NON-IRRIGATED AREAS ONLY. - REMOVE ALL CONTAINERS, BASKETS, WIRE ETC. FROM ROOTBALL. BROKEN OR DAMAGED ROOTBALLS WILL BE - LOOSEN SIDES OF ROOTBALL - 1/2 SPECIFIED BACKFILL MIX & 1/2 PIT SOIL. MOUND COMPACTED BACKFILL UNDER ROOTBALL, OR SET ON UNDISTURBED SOIL. - UNDISTURBED SUBGRADE 2x ROOTBALL

DECIDUOUS TREE

Scale: NTS

2 EVERGREEN TREE

3 SHRUB
Scale: NTS

PROJECT NUMBER 65120692

DRAWN BY

KW, RM, MLH

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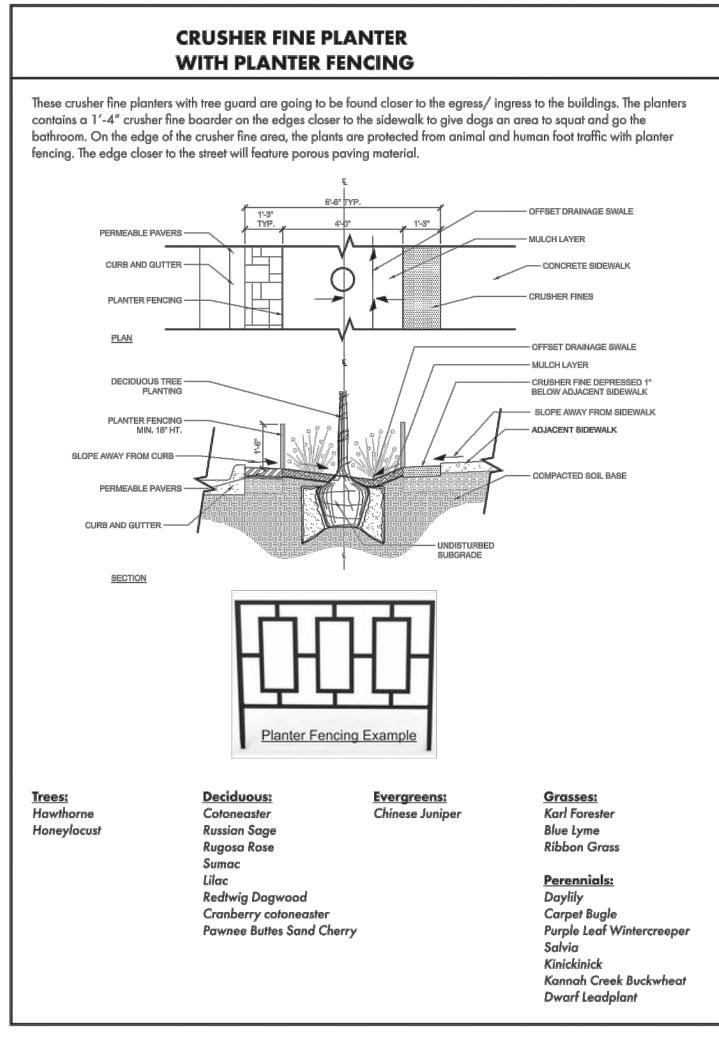
PROJECT


LINCOLN STATION APARTMENTS

LONE TREE, COLORADO

LANDSCAPE DETAILS

SHEET NUMBER



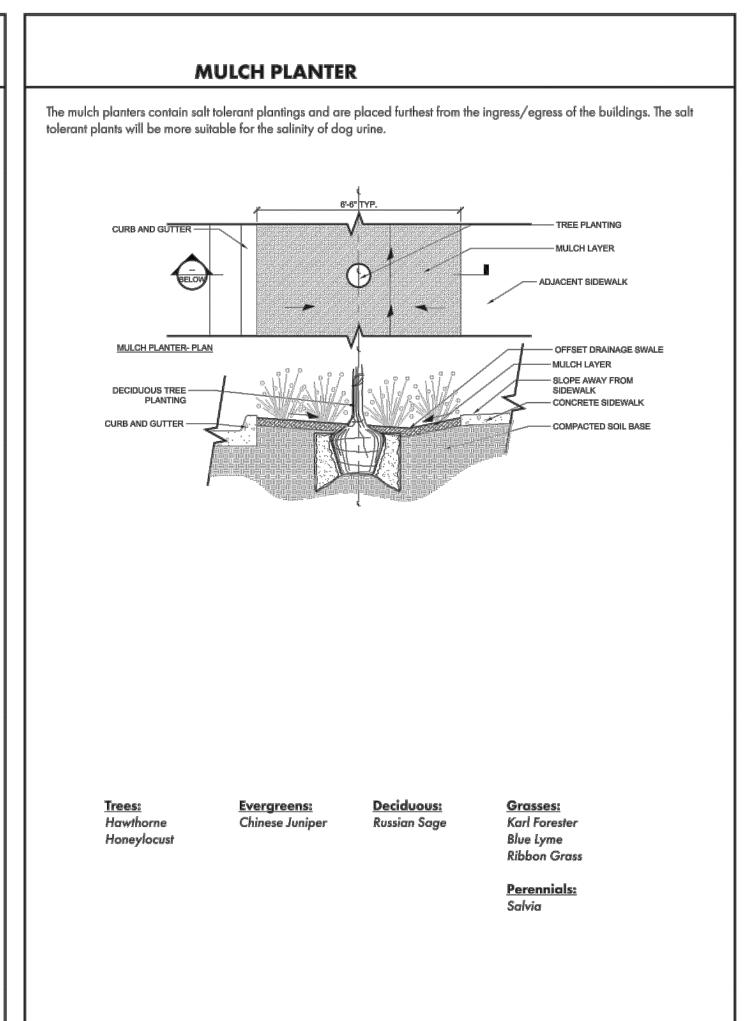

1 DOG FRIENDLY PLANTING EXHIBIT

PROJECT NUMBER 65120692

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DATE 07/23/2021

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PROJECT

LINCOLN STATION APARTMENTS

LONE TREE, COLORADO

SHEET TITLE

LANDSCAPE DETAILS

SHEET NUMBER

			PLANT S	CHEDULE			
	KEY	QTY	SCIENTIFIC NAME	COMMON NAME	SIZE	NOTES	HEIGHT/ WIDTH
	TREES			1		1	
8	ВТС	5	Fagus sylvatica 'Tricolor'	Tricolor Beech	2" cal.	B&B	30' HT., 25' SP
$m{\tilde{\cdot}}$	CAL	4	Catalpa speciosa	Western Catalpa	2.5" cal.	B&B	50' HT., 30' SP
$\tilde{\mathbf{S}}$	GLL	4	Tilia flavescens	Glenleven Linden	2.5" cal.	B&B	45' HT., 30' SP
Ŏ	HAC	2	Celtis occidentalis	Common Hackberry	2.5" cal.	B&B	50' HT., 40' SP
9	HFF	7	Carpinus betulus 'Frans Fontaine'	Frans Fontaine Hornbeam	2" cal.	B&B	30' HT., 15' SP
$reve{\mathcal{H}}$	HWT	8	Acer tataricum 'Garann'	Hot Wings Tatarian Maple	2" cal.	B&B	20' HT., 20' SP
○○○○○○○○○○○○○○○○○○○○○○○○○○○○○○○○○○	OGA	5	Pinus nigra 'Oregon Green'	Oregon Green Austrian Pine	8' ht.	B&B	20' HT., 15' SP
\bigcirc	RBU	12	Cercis canadensis	Eastern Redbud	2" cal.	B&B	20' HT., 15' SP
¥	SBH	4	Picea glauca 'Densata'	Black Hills Spruce	8' ht.	B&B	20' HT., 10' SP
8	SHA	2	Gleditsia triacanthos var. inermis 'Shademaster'	Shademaster Honeylocust	2.5" cal.	B&B	50' HT., 35' SP
0	SHAD	1	Gleditsia triacanthos var. inermis 'Shademaster'	Shademaster Honeylocust	3" cal.	B&B	50' HT., 35' SP
\mathfrak{D}	TCH	2	Crataegus crusgallii var inermis	Thornless Cockspur Hawthorn	2" cal.	B&B	20' HT., 15' SP
Ð	TOH	6	Crataegus x mordenensis	Toba Hawthorn	2" cal.	B&B	15' HT., 12' SP.
	SHRUB	S					
(AFD	87	Cornus sericea 'Farrow	Arctic Fire Dogwood	5 gal.	CONTAINER	
\Re	ANP	4	Thuja occidentalis 'Art Boe'	North Pole Arborvitae	5 gal.	CONTAINER	
$\tilde{*}$	CAC	23	Cotoneaster acutifolius	Peking Cotoneaster	5 gal.	CONTAINER	
0	ECO	157	Euonymus fortunei 'Colorata'	Purple Leaf Wintercreeper	5 gal.	CONTAINER	
0	EME	35	Euonymus fortunei	Emerald Gaiety Euonymus	5 gal.	CONTAINER	
①	FGT	9	Forsythia 'Courtasol'	Forsythia Gold Tide	5 gal.	CONTAINER*	
\odot	FQP	19	Chaenomeles japonica 'Cameo'	Cameo Quince	5 gal.	CONTAINER	
ð	GLS	22	Rhus aromatica 'Grow-Low'	Gro-Low Sumac	5 gal.	CONTAINER	
	HBG	4	Ilex x meserveae	Boy/Girl Holly	5 gal.	CONTAINER	
•	LOD	63	Ligustrum vulgare 'Lodense'	Lodense Privet	5 gal.	CONTAINER	
•	MEJ	9	Juniperus scopulorum 'Medora'	Medora Juniper	5 gal.	CONTAINER	
8	MUG	11	Pinus mugo	Mugo Pine	5 gal.	CONTAINER	
\odot	RAB	45	Ericameria nauseosa	Rabbitbrush	5 gal.	CONTAINER	
\oplus	RSA	74	Salvia yangii	Russian Sage	5 gal.	CONTAINER	
<u>ن</u>	VLE	17	Viburnum lentago	Nannyberry Viburnum	5 gal.	CONTAINER	
$\overset{\smile}{\odot}$	VMM	2	Viburnum burejaeticum 'P017S'	Mini Man Viburnum	5 gal.	CONTAINER	
, +}		29	Taxus × media 'Densiformis	Dense Spreading Yew	5 gal.	CONTAINER	
~	PEREN	NIALS		<u> </u>		1	
8	BUJ	21	Ajuga reptans	Burgundy Carpet Bugle	1 gal.	CONTAINER*	
•	DDY	174	Hemerocallis 'Stella D'Oro'	Stella D'oro Dwarf Daylily	1 gal.	CONTAINER*	
	GRASS		1.15morocaliio otolia b olo		. 34	JOHIAMEN	
*	BLO	196	Boutelous gracilis 'Blonde Ambition'	Blonde Ambition Blue Grama	1 gal.	CONTAINER*	
* ⊕	FRG	62	Calamagrostis acutiflora 'Karl	Karl Foerster Grass	1 gal.	CONTAINER*	
*	HFB	15	Pennisetum alopecuroides 'Little	Little Bunny Fountain Grass	1 gal.	CONTAINER	
			Bunny' Elymus arenarius 'Blue Dune'				
	VINES	63	Eiginus arenanus blue Dune	Blue Dune Lyme Grass	1 gal.	CONTAINER*	
			Lonicera japonica 'Halliana'	Hall's Honeysuckle	1 00	CONTAINED	
₩	HAL	9	сопісета јаропіса пашапа	пан s понеуsucкie	1 gal.	CONTAINER	J

NOTES:

PLANTING NOTES

- 1. WEED FABRIC SHALL NOT BE INSTALLED IN PLANTING BEDS UNLESS SPECIFICALLY SPECIFIED ON PLANS. PLANTING DESIGN IS INTENDED TO ALLOW PLANTS TO SPREAD THROUGHOUT PLANTING BEDS.
- 2. THE OWNER'S REPRESENTATIVE RESERVES THE RIGHT TO INSPECT AND TAG ALL PLANT MATERIAL PRIOR TO SHIPPING TO THE SITE. IN ALL CASES, THE OWNER'S REPRESENTATIVE MAY REJECT PLANT MATERIAL AT THE SITE IF MATERIAL IS DAMAGED, DISEASED, OR DECLINING IN HEALTH AT THE TIME OF ONSITE INSPECTIONS OR IF THE PLANT MATERIAL DOES NOT MEET THE MINIMUM SPECIFIED STANDARD IDENTIFIED ON THE PLANS AND IN THE SPECIFICATIONS. THE CONTRACTOR SHALL COORDINATE WITH THE OWNER'S REPRESENTATIVE FOR INSPECTION AND APPROVAL OF ALL MATERIALS AND PRODUCTS PRIOR TO INSTALLATION.
- 3. REFER TO IRRIGATION PLANS FOR LIMITS AND TYPES OF IRRIGATION DESIGNED FOR THE LANDSCAPE. IN NO CASE SHALL IRRIGATION BE EMITTED WITHIN THE MINIMUM DISTANCE FROM BUILDING OR WALL FOUNDATIONS AS STIPULATED IN THE GEOTECHNICAL REPORT. ALL IRRIGATION DISTRIBUTION LINES, HEADS AND EMITTERS SHALL BE KEPT OUTSIDE THE MINIMUM DISTANCE AWAY FROM ALL BUILDING AND WALL FOUNDATIONS AS STIPULATED IN THE GEOTECHNICAL REPORT.
- 4. LANDSCAPE MATERIAL LOCATIONS SHALL HAVE PRECEDENCE OVER IRRIGATION MAINLINE AND LATERAL LOCATIONS. COORDINATE INSTALLATION OF IRRIGATION EQUIPMENT SO THAT IT DOES NOT INTERFERE WITH THE PLANTING OF TREES OR OTHER LANDSCAPE MATERIAL.
- 5. THE LANDSCAPE CONTRACTOR SHALL BE RESPONSIBLE FOR ENSURING POSITIVE DRAINAGE EXISTS IN ALL LANDSCAPE AREAS. SURFACE DRAINAGE ON LANDSCAPE AREAS SHALL NOT FLOW TOWARD STRUCTURES AND FOUNDATION. MAINTAIN SLOPE AWAY FROM FOUNDATIONS PER THE GEOTECHNICAL REPORT RECOMMENDATIONS. ALL LANDSCAPE AREAS BETWEEN WALKS AND CURBS SHALL DRAIN FREELY TO THE CURB UNLESS OTHERWISE IDENTIFIED ON THE GRADING PLAN. IN NO CASE SHALL THE GRADE, TURF THATCH, OR OTHER LANDSCAPE MATERIAL DAM WATER AGAINST WALKS. MINIMUM SLOPES ON LANDSCAPE SHALL BE 2%; MAXIMUM SLOPE SHALL BE 25% UNLESS SPECIFICALLY IDENTIFIED ON THE PLANS OR APPROVED BY THE OWNER'S REPRESENTATIVE.
- 6. TREES SHALL NOT BE LOCATED IN DRAINAGE SWALES, DRAINAGE AREAS, OR UTILITY EASEMENTS. CONTACT OWNER'S REPRESENTATIVE FOR RELOCATION OF PLANTS IN QUESTIONABLE AREAS PRIOR TO INSTALLATION.
- 7. ALL EXISTING TREES SHALL BE SAVED AND PROTECTED (TRANSPLANTED IF NECESSARY), UNLESS OTHERWISE NOTED.
- 8. TO THE MAXIMUM EXTENT FEASIBLE, TOPSOIL THAT IS REMOVED PRIOR TO CONSTRUCTION SHALL BE COLLECTED, SAVED, AND PROTECTED FOR LATER USE ON AREAS REQUIRING REVEGETATION (SEED) AND/ OR LANDSCAPING.
- 9. ALL TURF AND BED AREAS SHALL RECEIVE ORGANIC SOIL PREPARATION AT A RATE OF (4) FOUR CUBIC YARDS PER 1000 SQUARE FEET TILLED TO A DEPTH OF 6 INCHES OR AS NOTED IN THE TECHNICAL SPECIFICATIONS. ALL SEEDED AREAS SHALL RECEIVE ORGANIC SOIL PREPARATION AT A RATE RATE RECOMMENDED BY SEED PRODUCER. SEE TECHNICAL SPECIFICATIONS FOR ADDITIONAL INFORMATION.
- 10. PRIOR TO INSTALLING OF PLANT MATERIALS, ALL AREAS THAT HAVE BEEN COMPACTED OR DISTURBED BY CONSTRUCTION ACTIVITY SHALL BE THOROUGHLY LOOSENED, REPAIRED AND SEEDED IF NECESSARY. SEE SPECIFIED SEED MIX INFORMATION.
- 11. THE CONTRACTOR IS EXPECTED TO KNOW AND UNDERSTAND THE CITY'S SPECIFICATIONS FOR LANDSCAPE AND IRRIGATION.
- 12. ALL PLANTS OF THE SAME SPECIES AND SIZE SHALL HAVE MATCHING HEIGHT AND FORM, UNLESS OTHERWISE NOTED. ALL PLANTS SHALL CONFORM TO THE "AMERICAN STANDARD FOR NURSERY STOCK."
- 13. THE CONTRACTOR IS RESPONSIBLE FOR VERIFYING ALL PLANT QUANTITIES. GRAPHIC SYMBOLS ON LANDSCAPE DRAWINGS TAKES PRECEDENCE OVER WRITTEN PLANT QUANTITIES.
- 14. ALL PLANTS SHALL BE PLANTED USING AN EQUALLY SPACED TRIANGULAR PATTERN, UNLESS OTHERWISE NOTED AND/ OR SHOWN ON THE LANDSCAPE DRAWINGS.
- 15. ALL PLANTS INSTALLED SHALL FOLLOW THE PLANT SCHEDULE ON THE APPROVED LANDSCAPE DRAWINGS. SUBSTITUTIONS MUST BE APPROVED BY THE LANDSCAPE ARCHITECT. ANY CHANGES TO THE APPROVED LANDSCAPE PLAN, TO INCLUDE SUBSTITUTIONS, MUST BE APPROVED BY THE CITY.
- 16. CONTRACTOR SHALL REPORT ANY DISCREPANCY FOUND IN THE FIELD VERSUS THE LANDSCAPE DRAWINGS IMMEDIATELY TO THE LANDSCAPE ARCHITECT AND/ OR OWNER'S REPRESENTATIVE PRIOR TO ANY CONSTRUCTION OR DEMOLITION ACTIVITY. FAILURE TO MAKE SUCH CONFLICTS KNOWN WILL RESULT IN THE CONTRACTOR'S LIABILITY TO RELOCATE OR REPAIR.
- 17. THE FINAL LOCATION OF ALL PLANTS SHALL BE SUBJECT TO THE APPROVAL OF THE OWNER'S REPRESENTATIVE PRIOR TO
- 18. CONTRACTOR SHALL PROVIDE AT LEAST A ONE YEAR WARRANTY FOR ALL PLANT MATERIAL FROM THE DATE OF FINAL INSPECTION, UNLESS OTHERWISE DIRECTED BY LANDSCAPE ARCHITECT AND/OR OWNER.
- 19. ALL PLANTS SHALL BE WATERED, CARED FOR, AND PROTECTED FROM DAMAGING WEATHER EFFECTS WHEN NECESSARY. PROVIDE ADDITIONAL WINTER WATERING, AS REQUIRED, TO ENSURE SUCCESSFUL PLANT INSTALLATION AND PREVENT INITIAL DIE OFFS.
- 20. ALL PLANTS SHALL BE INSTALLED IMMEDIATELY UPON DELIVERY TO THE PROJECT SITE. IF THIS IS NOT POSSIBLE, PLANTS SHALL BE HEELED IN AND WATERED TO HELP PREVENT ANY DAMAGE.
- 21. ALL TREES ARE TO BE STAKED WITH WOOD STAKES AND GUYED FOR A PERIOD OF ONE YEAR PER THE DETAILS. THE CONTRACTOR SHALL BE RESPONSIBLE FOR REMOVING WOOD STAKES AT THE END OF 1 YEAR FROM ACCEPTANCE OF LANDSCAPE INSTALLATION BY THE OWNER'S REPRESENTATIVE. OBTAIN APPROVAL BY OWNER'S REPRESENTATIVE PRIOR TO REMOVAL.
- 22. ALL TREES INSTALLED ABOVE RETAINING WALLS UTILIZING GEO-GRID MUST BE HAND DUG TO PROTECT GEO-GRID. IF GEO-GRID MUST BE CUT TO INSTALL TREES, APPROVAL MUST BE GIVEN BY OWNER'S REPRESENTATIVE PRIOR TO DOING WORK.
- 23. TREE WRAP SHALL BE APPLIED IN LATE FALL AFTER INSTALLATION AND REMOVED THE FOLLOWING SPRING. TREES GREATER THAN 4" IN CALIPER MAY NOT REQUIRE TREE WRAP IF BARK IS SUFFICIENTLY DEVELOPED. OBTAIN APPROVAL FROM OWNER'S REPRESENTATIVE FOR ANY TREES THAT WILL NOT BE WRAPPED.
- 24. CONTRACTOR SHALL OBTAIN SOIL SAMPLES FROM A MINIMUM OF 5 SUITABLE LOCATIONS AND SUBMIT SAMPLES TO A STATE-LICENSED SOIL TESTING LABORATORY, SUCH AS COLORADO ANALYTICAL OR COLORADO STATE UNIVERSITY SOILS LAB, SPECIALIZING IN THE ANALYSIS OF SOIL AND IN MAKING RECOMMENDATIONS FOR THE INTRODUCTION OF ORGANIC AMENDMENTS IN LANDSCAPE PLANTING AREAS. THE RESULTS OF THE SOIL ANALYSIS AND RECOMMENDATIONS SHALL BE FORWARDED TO THE OWNER'S REPRESENTATIVE ALONG WITH THE CONTRACTOR'S RECOMMENDATIONS FOR SOIL AMENDMENT MATERIALS AND QUANTITIES.

SOIL AMENDMENT

- 1. ALL SOILS FOR GENERAL LANDSCAPING AREAS OR ON WHICH ANY COOL-SEASON LAWN, TURF OR SOD IS TO BE INSTALLED MUST BE PROPERLY AMENDED WITH ORGANIC MATTER SUCH AS COMPOST AND AGED MANURE. A MINIMUM OF FOUR (4) CUBIC YARDS OF COMPOST PER EACH ONE THOUSAND (1,000) SQUARE FEET OF SOIL SHOULD BE INCORPORATED TO A DEPTH OF AT LEAST FOUR (4) TO SIX (6) INCHES BY ROTOTILLING OR OTHER SUITABLE MEASURE. SOIL AMENDMENTS FOR NATIVE PLANTS AND GRASSES ARE NOT REQUIRED.
- 2. STRUCTURED SOILS THAT INCLUDE ROCK AND SAND TO REDUCE COMPACTION AND INCREASE POROSITY FOR ROOT GROWTH MAY BE REQUIRED WHERE TREE GRATES ARE PROPOSED.

MULCH AND GROUNDCOVERS

1. ORGANIC MULCH SUCH AS WOOD/BARK SHALL BE INSTALLED AND MAINTAINED TO A DEPTH OF FOUR (4) INCHES. ROCK MULCH IS DISCOURAGED AS MULCH EXCEPT IN AREAS OF HIGH WINDS OR AREAS PRONE TO EROSION AS EVALUATED BY THE COMMUNITY DEVELOPMENT DEPARTMENT. WHERE ROCK MULCH IS USED, PLACE TO A DEPTH OF THREE (3) INCHES. THE USE OF IMPERMEABLE SHEET PLASTIC AS A WEED BARRIER IS NOT PERMITTED.

PROJECT NUMBER 65120692

DRAWN BY

KW, RM, MLH

DATE 07/23/2021

REVISIONS

REVISION 1 FEB 10, 2021 REVISION 2 MAR 16, 2021 REVISION 3 JUNE 10, 2021 REVISION 4 JULY 06, 2021 REVISION 5 JULY 23, 2021



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LAND PLANNING AND
LANDSCAPE ARCHITECTURE

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PREPARED FOR CENTURY COMMUNITIES



PROJECT

LINCOLN STATION APARTMENTS


LONE TREE, COLORADO


PLANT
SCHEDULE AND
NOTES

SHEET NUMBER

^{*} DENOTES DOG FRIENDLY PLANTS

POINT OF CONNECTION

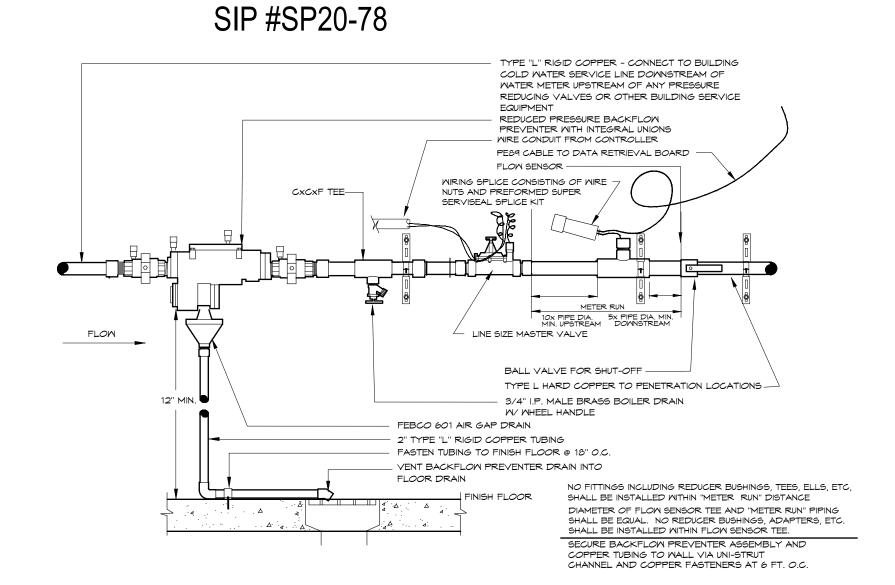


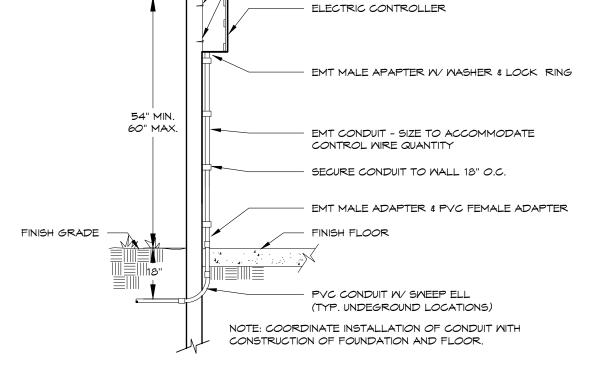


SECURE CONTROLLER TO

MALL WITH ANCHOR BOLTS



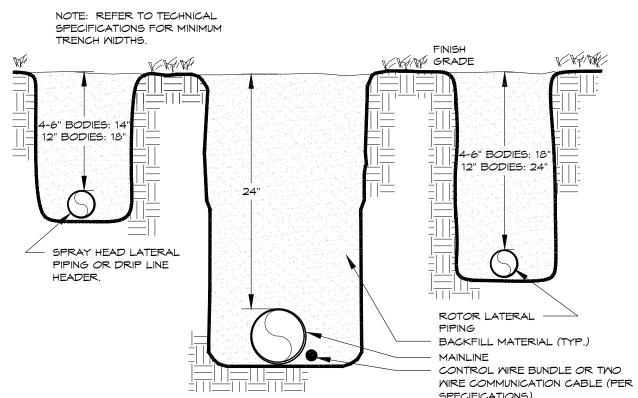

TRENCH	
24" MAINLINE	

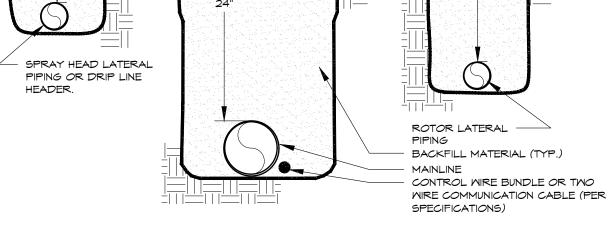

TRENCH	

LINCOLN **STATION**

LONE TREE, COLORADO

80124

APARTMENTS

PROJECT NUMBER

65120692

DRAWN BY

DATE

7/23/2021

REVISIONS

REVISION 1

REVISION 4 REVISION 5 FEB 10, 2021

MAR 16, 2021 JUNE 10, 2021

JULY 6, 2021

JULY 23, 2021

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Planning | Geospatial Solutions 5970 GREENWOOD PLAZA BLVD.

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GREENWOOD VILLAGE, CO. 8011

IRRIGATION NOTES, SCHEDULE & **DETAILS**

SHEET NUMBER

19 OF 35


IRRIGATION SCHEDULE SYMBOL DETAIL NO. DESCRIPTION ELECTRIC CONTROLLER MEATHER SENSOR DEVICE (RAIN/FREEZE) PVC MAINLINE - 2-1/2" OR SMALLER ______ PVC SLEEVING RP BACKFLOW PREVENTER (FS) FLOW SENSOR MASTER VALVE

IRRIGATION DEVELOPMENT DESIGN NOTES


- 1. THE IRRIGATION SYSTEM SHALL BE DESIGNED TO PROVIDE PEAK SEASON IRRIGATION WITHIN AN THREE NIGHT, TEN HOUR PER NIGHT WATERING PERIOD. IRRIGATION SHALL OCCUR BETWEEN THE HOURS OF 8:00 PM AND 6:00 AM.
- 2. THE MAINLINE SYSTEM WILL BE DESIGNED SUCH THAT VELOCITIES WITHIN THE MAINLINE PIPING DO NOT EXCEED FIVE FEET PER SECOND.
- 3. THE MAXIMUM FLOW RATE REQUIRED FOR THE SITE IS 10 GPM. THE STATIC PRESSURE REQUIRED AT THE SITE IS STATED AT EACH POINT OF CONNECTION.
- 4. THE IRRIGATION INFORMATION SHOWN ON THESE PLANS IS CONCEPTUAL.
- 5. IRRIGATION DESIGN APPROACH
- 5.1. TURF AREAS 5.1.1. SMALL AREAS (25 FEET WIDE OR LESS) SHALL BE IRRIGATED WITH FIXED NOZZLE POP-UP SPRAY HEADS WITH MATCHED PRECIPITATION NOZZLES. NOZZLES SHALL BE SIZES TO PROVIDE HEAD TO HEAD COVERAGE.
- 5.1.2. LARGE TURF AREAS (WIDER THAN 25 FEET) SHALL BE IRRIGATED WITH GEAR DRIVEN ROTOR HEADS WITH A MINIMUM PRECIPITATION RATE OF .45" PER HOUR FOR A FULL
- 5.2. SHRUB BED AREAS BED AREAS WITH PLANT MATERIAL ONE GALLON IN SIZE OR LARGER SHALL BE DRIP IRRIGATED.
- 6. SUBSURFACE IRRIGATION WHERE REQUIRED BY LOCAL CODES, SUBSURFACE IRRIGATION SHALL BE INSTALLED IN SHRUB BEDS AND/OR NATIVE AREAS LESS THAN 6 FT. WIDE.
- 7. IRRIGATION SYSTEM SHALL BE FULLY AUTOMATIC AND INCLUDE A MEATHER SENSING DEVICE THAT INCLUDES RAIN AND FREEZE SENSING.
- 8. ANY IRRIGATION EQUIPMENT MOUNTED TO THE BUILDING SHALL BE PAINTED TO MATCH THE BUILDING.

DIRECTORY IRRIGATION SCHEDULE **IRRIGATION NOTES** IRRIGATION PLAN OVERALL IRRIGATION PLANS 21 - 24

IRRIGATION DETAILS

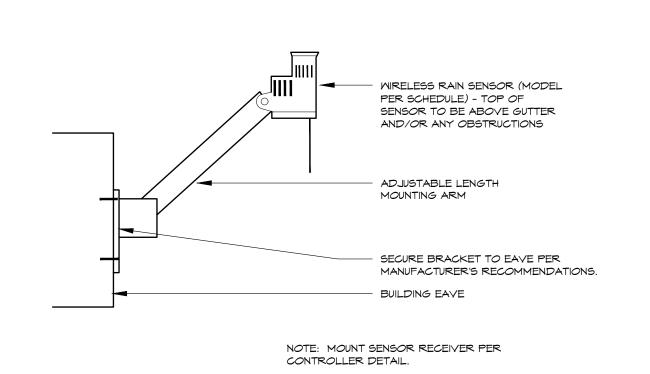

WEATHER SENSOR **EAVE MOUNTED - Wireless**

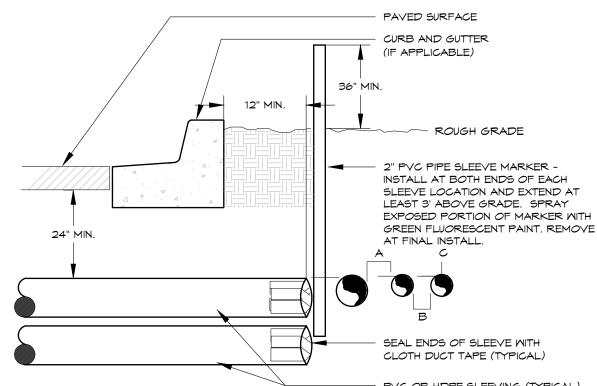


- ALL SLEEVE MATERIAL PER IRRIGATION SCHEDULE, SIZE AS NOTED ON
- INSTALL SLEEVES IN SIDE-BY-SIDE CONFIGURATION WHERE MULTIPLE SLEEVES ARE TO BE INSTALLED. SPACE SLEEVES 4" TO 6" APART. DO NOT STACK SLEEVES VERTICALLY. CONTRACTOR TO COORDINATE WITH FLATWORK INSTALLER TO BRAND A
- "V" IN SIDEWALK OR CURB AT BOTH ENDS OF SLEEVE CROSSING. SLEEVING THROUGH OR UNDER RETAINING WALLS, PLANTER WALLS, POND LINING, OR WATER QUALITY AREAS SHALL BE COORDINATED WITH CIVIL
- WORK AT APPROXIMATE LOCATIONS SHOWN. AN INDIVIDUAL SLEEVE SHALL CONTAIN NO MORE THAN ONE PIPE OR WIRE


IRRIGATION SLEEVING

TYPICAL





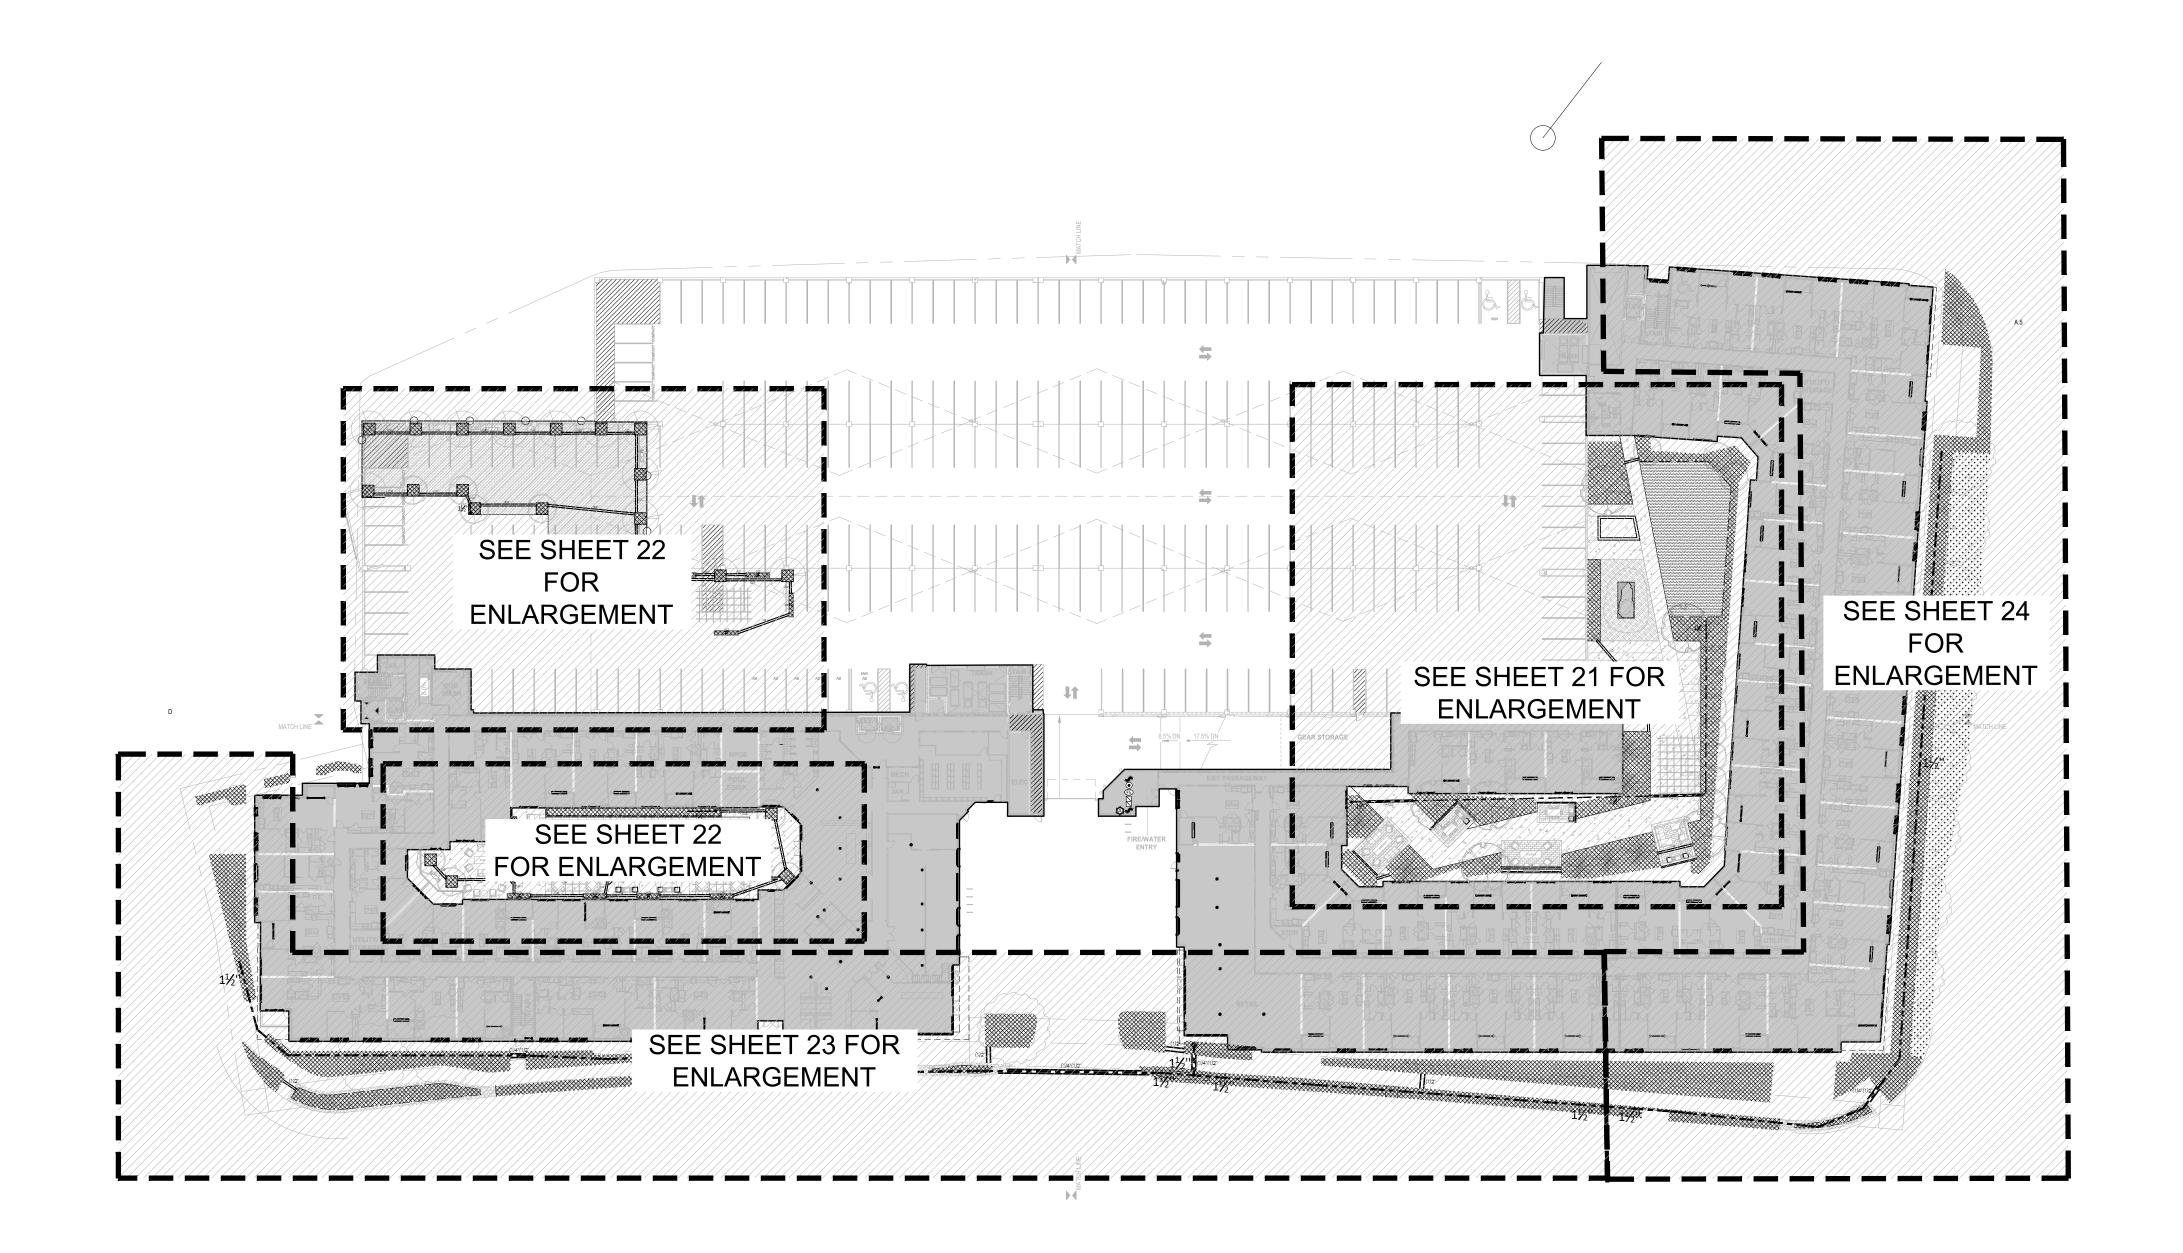

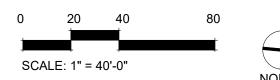



DIRECTORY **IRRIGATION SCHEDULE IRRIGATION NOTES** IRRIGATION PLAN OVERALL **IRRIGATION PLANS** 21 - 24

IRRIGATION DETAILS

19





65120692 DRAWN BY

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7/23/2021

REVISIONS

REVISION 1 FEB 10, 2021 REVISION 2 MAR 16, 2021 JUNE 10, 2021 REVISION 4 JULY 6, 2021 REVISION 5 JULY 23, 2021



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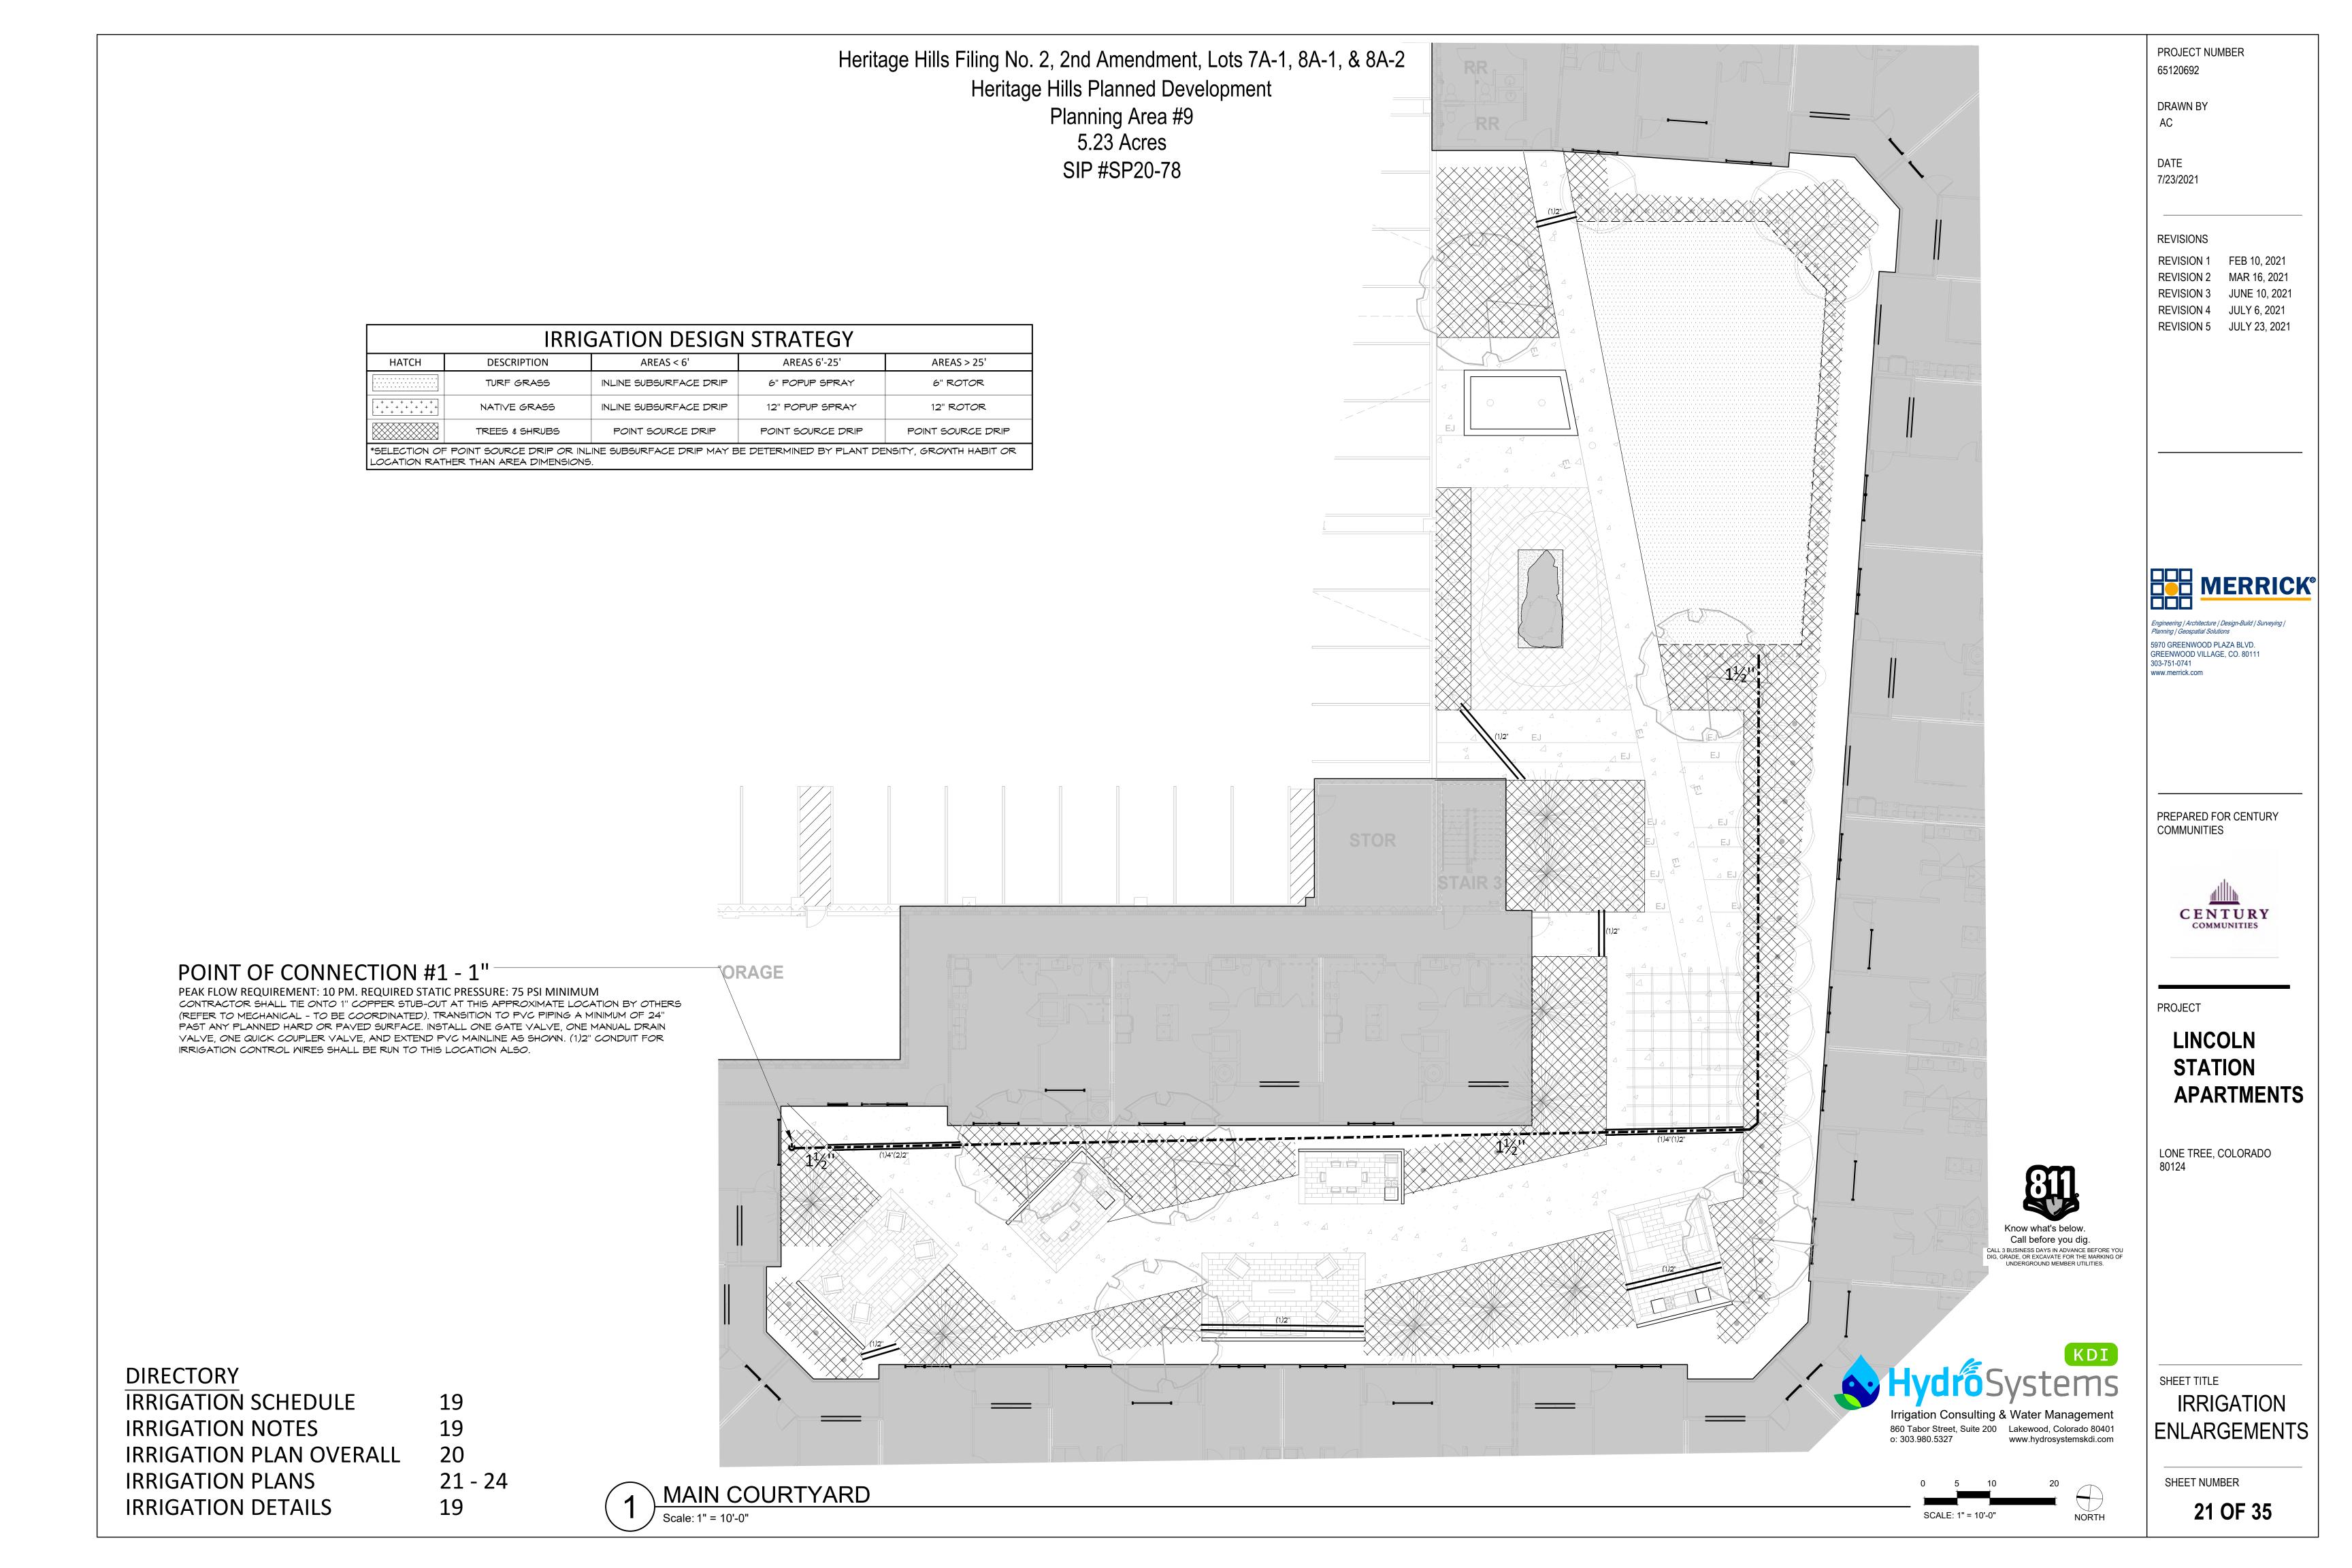



LINCOLN **STATION APARTMENTS**

LONE TREE, COLORADO 80124

SHEET TITLE IRRIGATION PLAN **OVERALL**

SHEET NUMBER



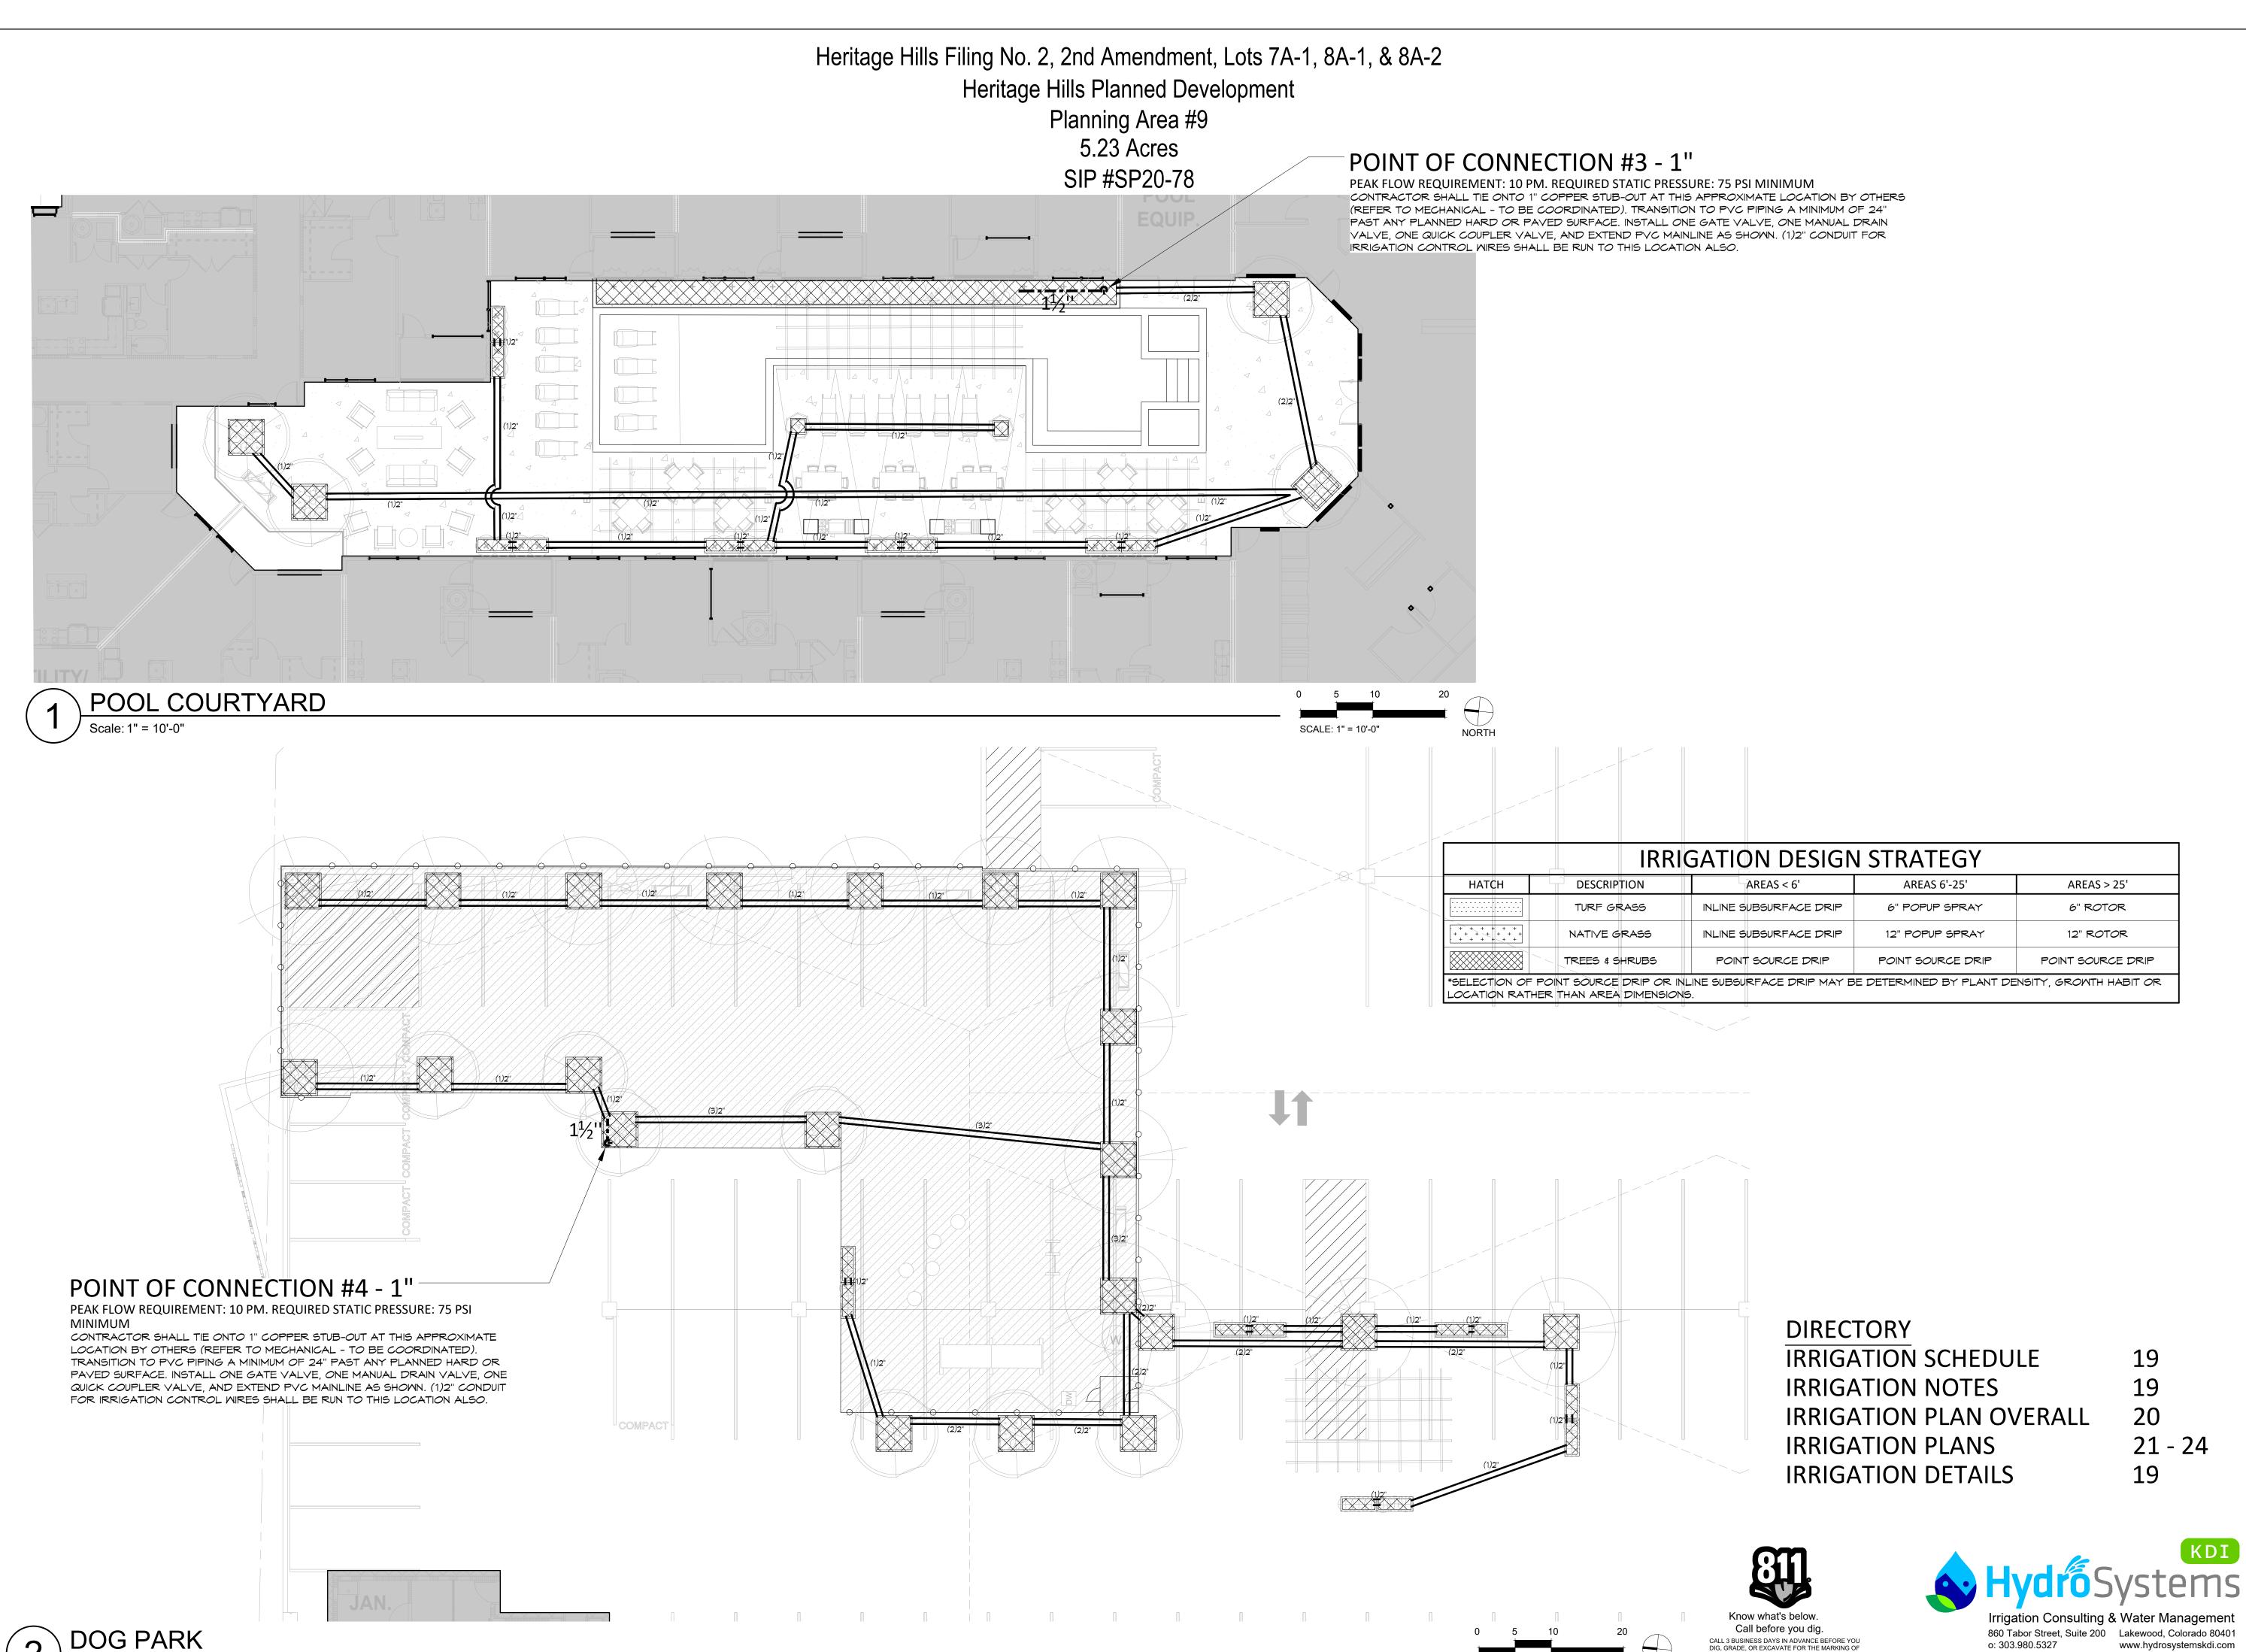

SCALE: 1" = 10'-0"

PROJECT NUMBER 65120692

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PROJECT

LINCOLN STATION APARTMENTS

LONE TREE, COLORADO 80124

SHEET TITLE

IRRIGATION ENLARGEMENTS


SHEET NUMBER

Heritage Hills Filing No. 2, 2nd Amendment, Lots 7A-1, 8A-1, & 8A-2


Heritage Hills Planned Development

Planning Area #9 5.23 Acres SIP #SP20-78

IRRIGATION DESIGN STRATEGY								
HATCH	HATCH DESCRIPTION AREAS < 6' AREAS 6'-25' AREAS > 25'							
	TURF GRASS	INLINE SUBSURFACE DRIP	6" POPUP SPRAY	6" ROTOR				
+ + + + + + + + + + + + + + + + + + + +	NATIVE GRASS	INLINE SUBSURFACE DRIP	12" POPUP SPRAY	12" ROTOR				
TREES & SHRUBS POINT SOURCE DRIP POINT SOURCE DRIP POINT SOURCE DRIP								
*SELECTION OF POINT SOURCE DRIP OR INLINE SUBSURFACE DRIP MAY BE DETERMINED BY PLANT DENSITY, GROWTH HABIT OR LOCATION RATHER THAN AREA DIMENSIONS.								

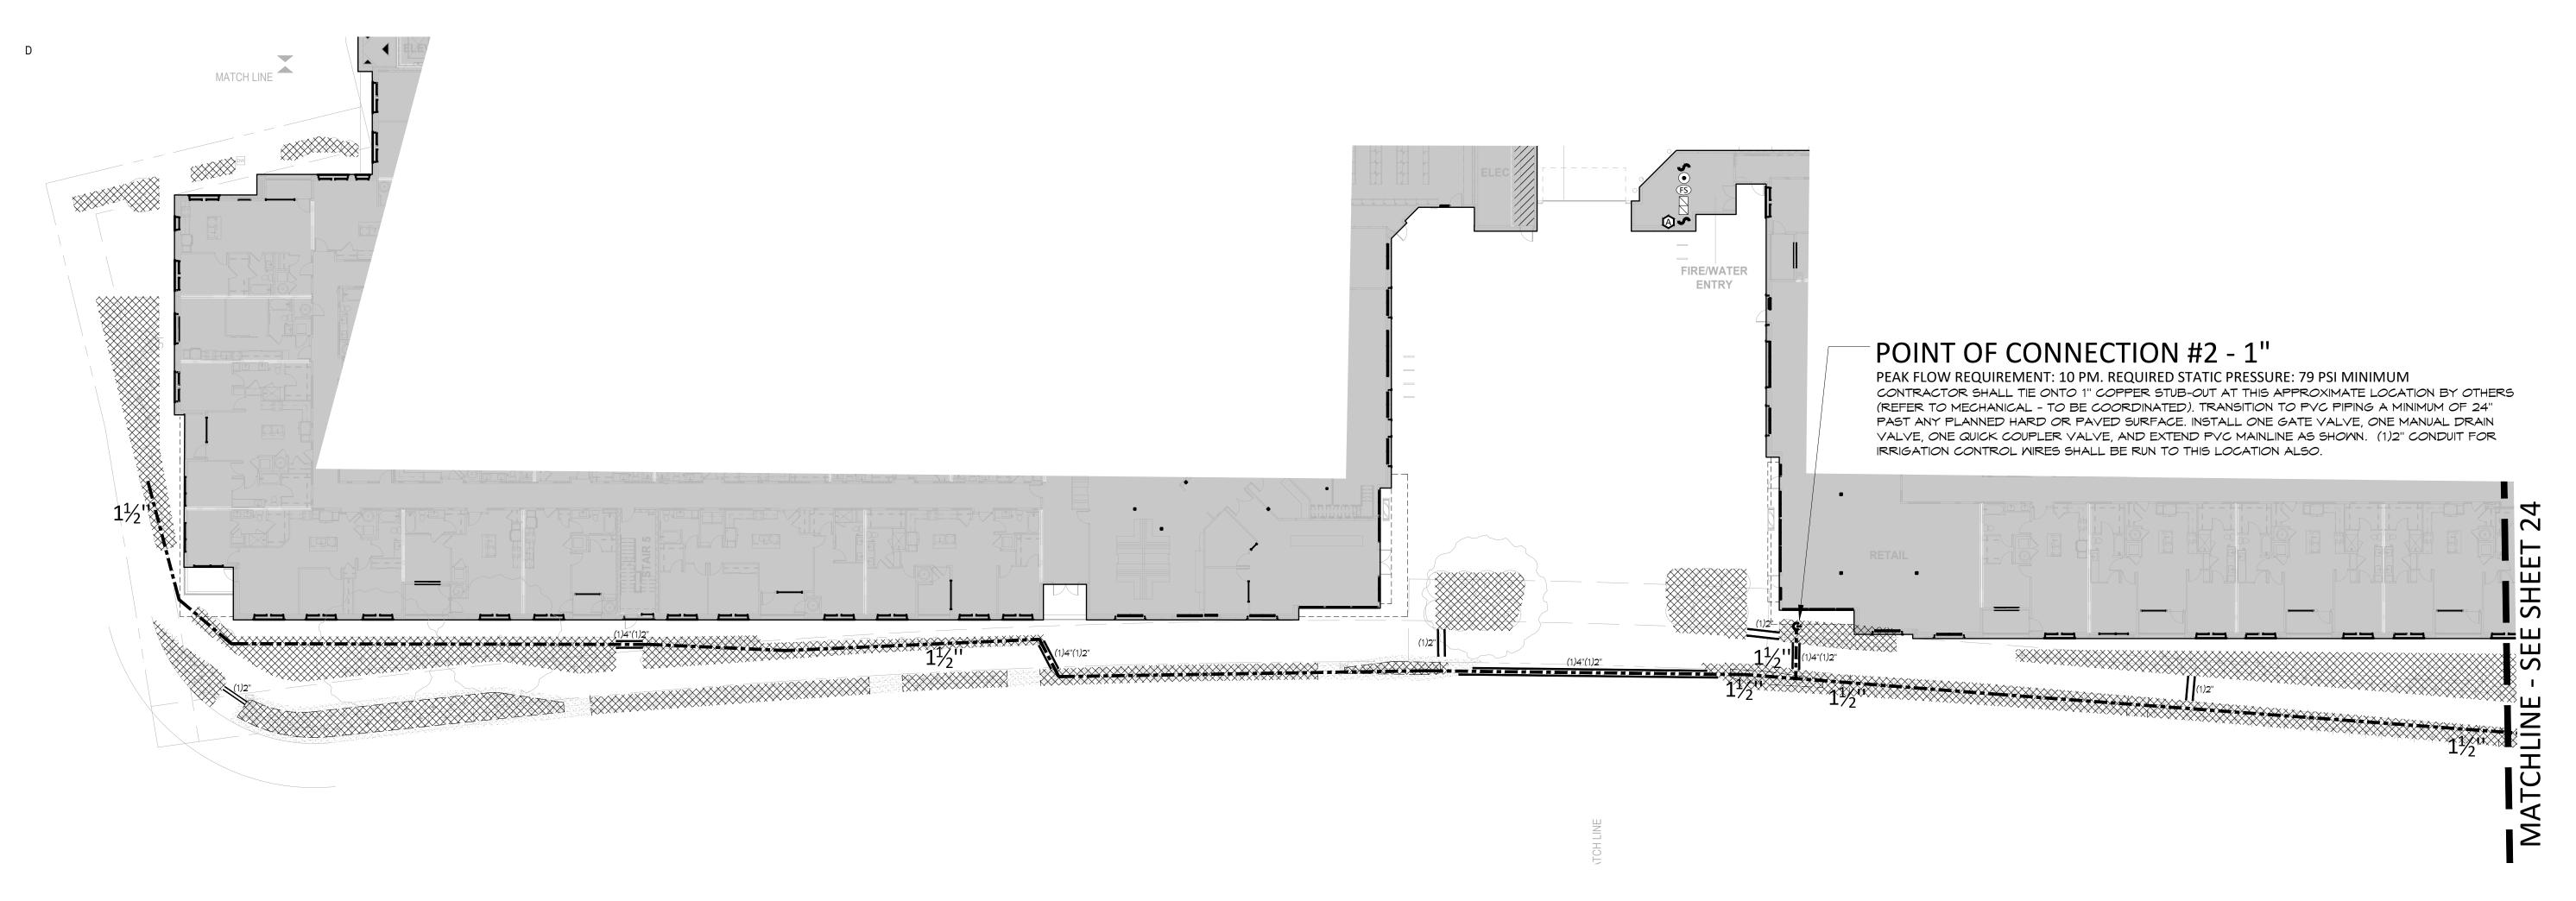

ROW
| Scale: 1" = 20'-0"

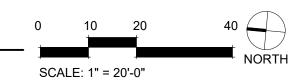

DIRECTORY

IRRIGATION SCHEDULE 19
IRRIGATION NOTES 19
IRRIGATION PLAN OVERALL 20
IRRIGATION PLANS 21 - 24
IRRIGATION DETAILS 19





PROJECT NUMBER 65120692

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LINCOLN STATION APARTMENTS


LONE TREE, COLORADO 80124

SHEET TITLE

IRRIGATIO

IRRIGATION ENLARGEMENTS

SHEET NUMBER

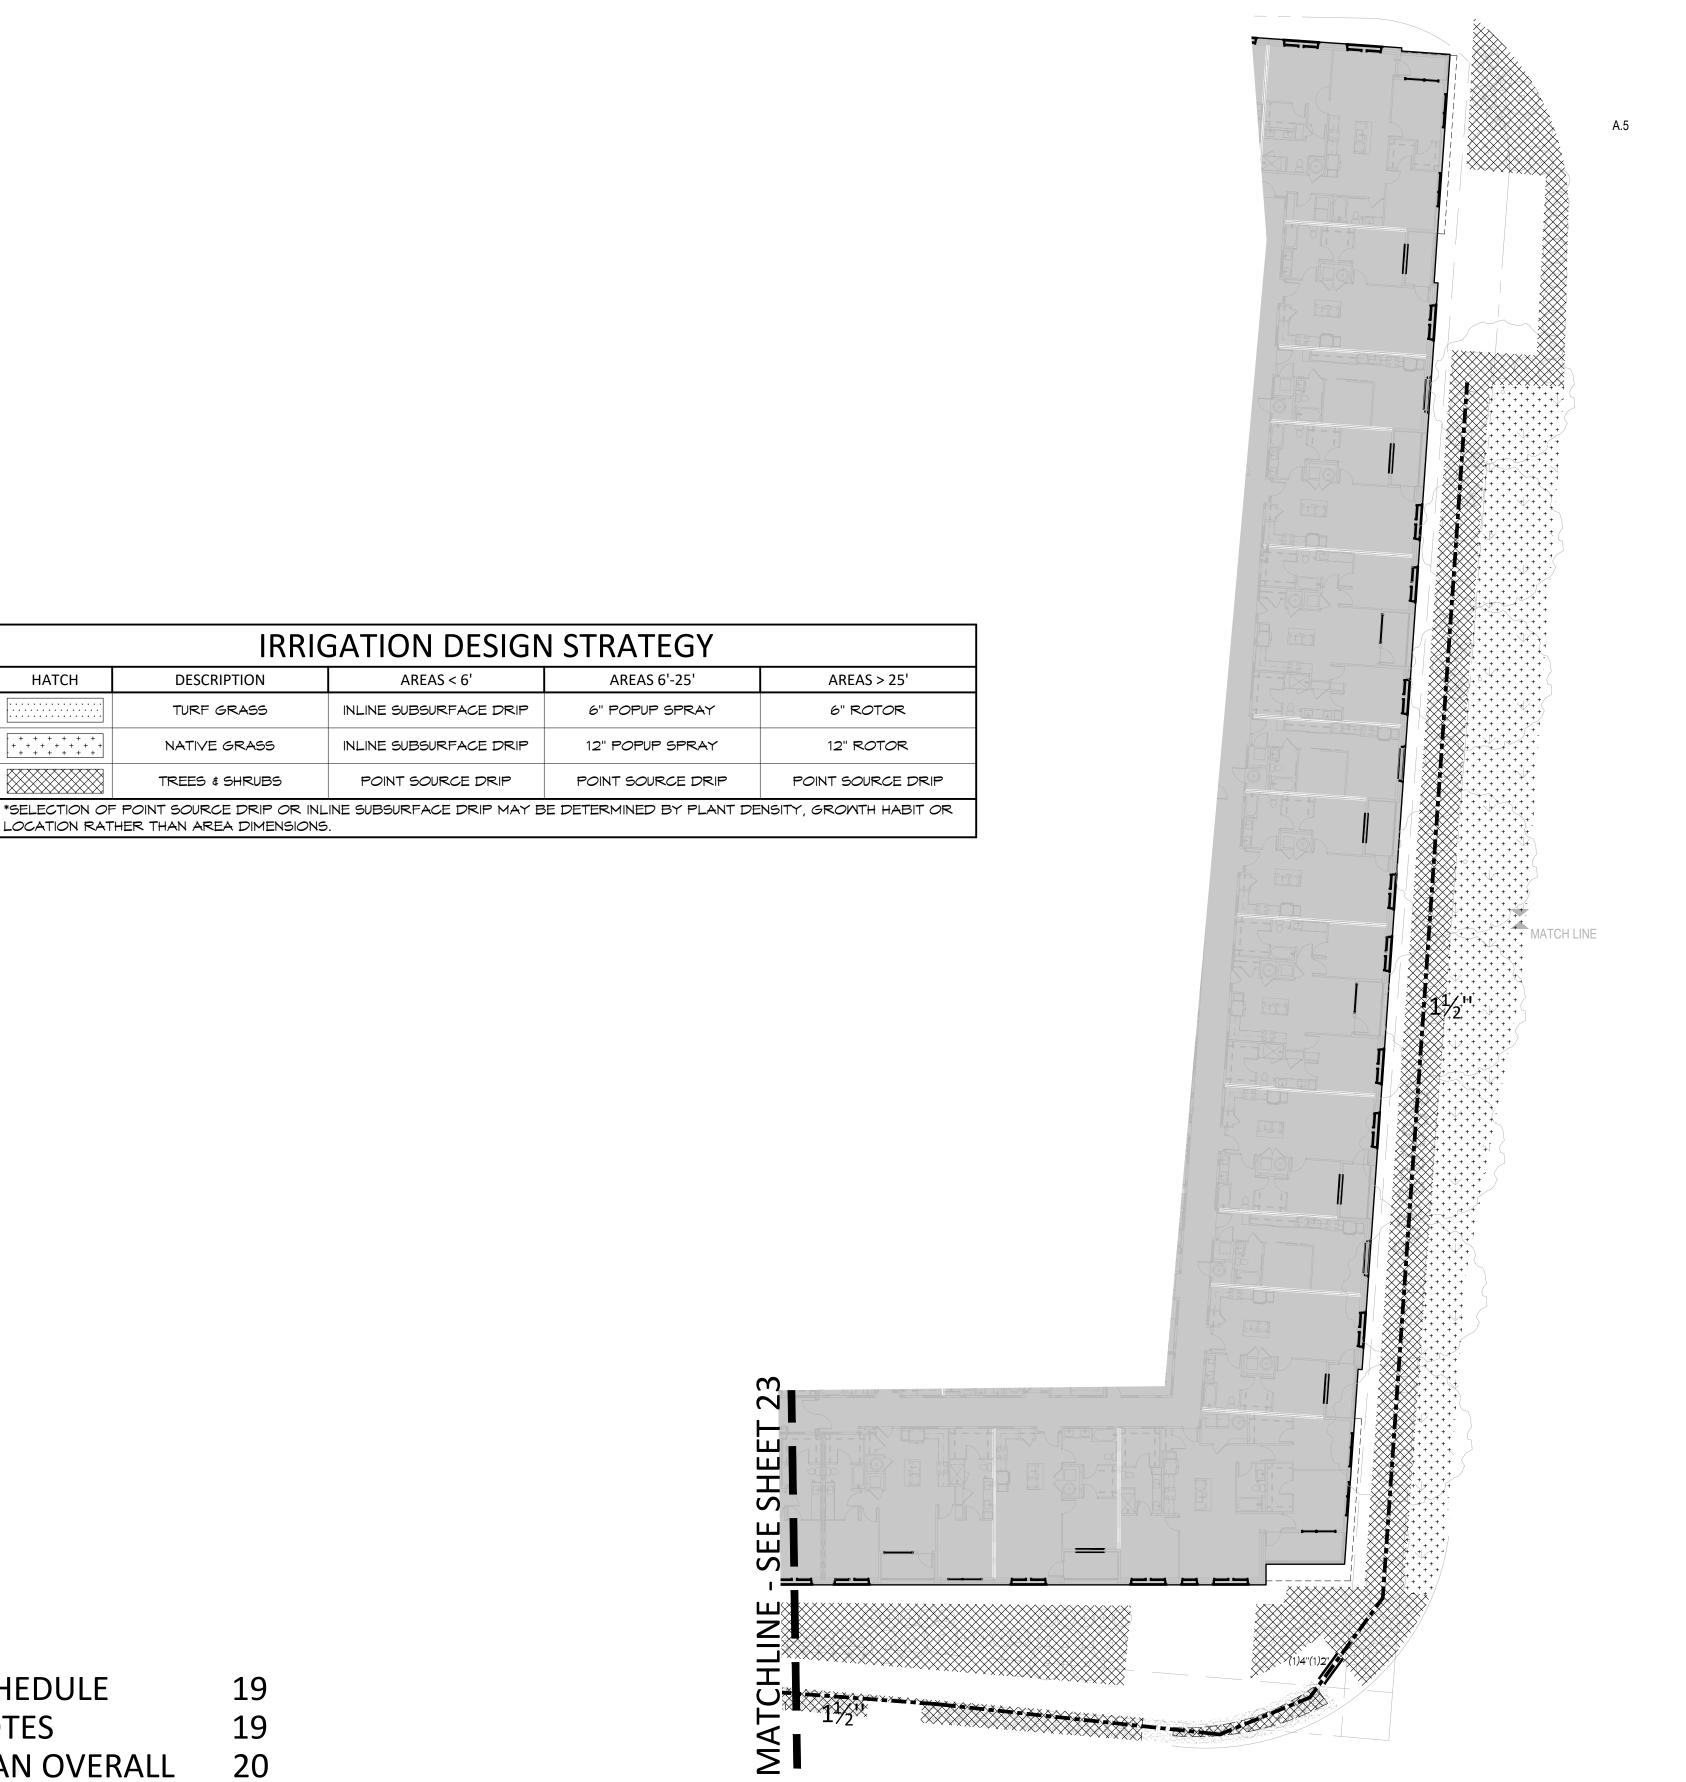

DIRECTORY IRRIGATION SCHEDULE 19 **IRRIGATION NOTES** IRRIGATION PLAN OVERALL 21 - 24 **IRRIGATION PLANS** 19 IRRIGATION DETAILS

HATCH

DESCRIPTION

TURF GRASS

NATIVE GRASS

TREES & SHRUBS

LOCATION RATHER THAN AREA DIMENSIONS.

IRRIGATION DESIGN STRATEGY

AREAS 6'-25'

6" POPUP SPRAY

12" POPUP SPRAY

POINT SOURCE DRIP

SHEET 23

SEE

AREAS < 6'

INLINE SUBSURFACE DRIP

INLINE SUBSURFACE DRIP

POINT SOURCE DRIP







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LINCOLN **STATION APARTMENTS**

LONE TREE, COLORADO 80124

SHEET TITLE

IRRIGATION ENLARGEMENTS

SHEET NUMBER

GENERL NOTEB:

CALCULATION GRID FOR PARKING (5FT X 5FT) @ GROUND LEVEL.
 CALCULATION GRID FOR OTHER (3F X 3FT) @ GROUND LEVEL.

DRAWN BY

65120692

PROJECT NUMBER

DATE

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REVISION 1 FEB 10, 2021 REVISION 2 MAR 16, 2021 REVISION 3 JUNE 10, 2021 REVISION 4 JULY 6, 2021

Jordan & Skala

Engineers 555 17th Street, • Suite 700 Denver, CO 80202

p. 303.586.2375 • f. 303.586.2376 Project Number: 2080192 Drawn By: EJ Checked By: SL


PROJECT

LINCOLN **STATION APARTMENTS**


LONE TREE, COLORADO

SHEET TITLE **PHOTOMETRIC** PLAN


SHEET NUMBER

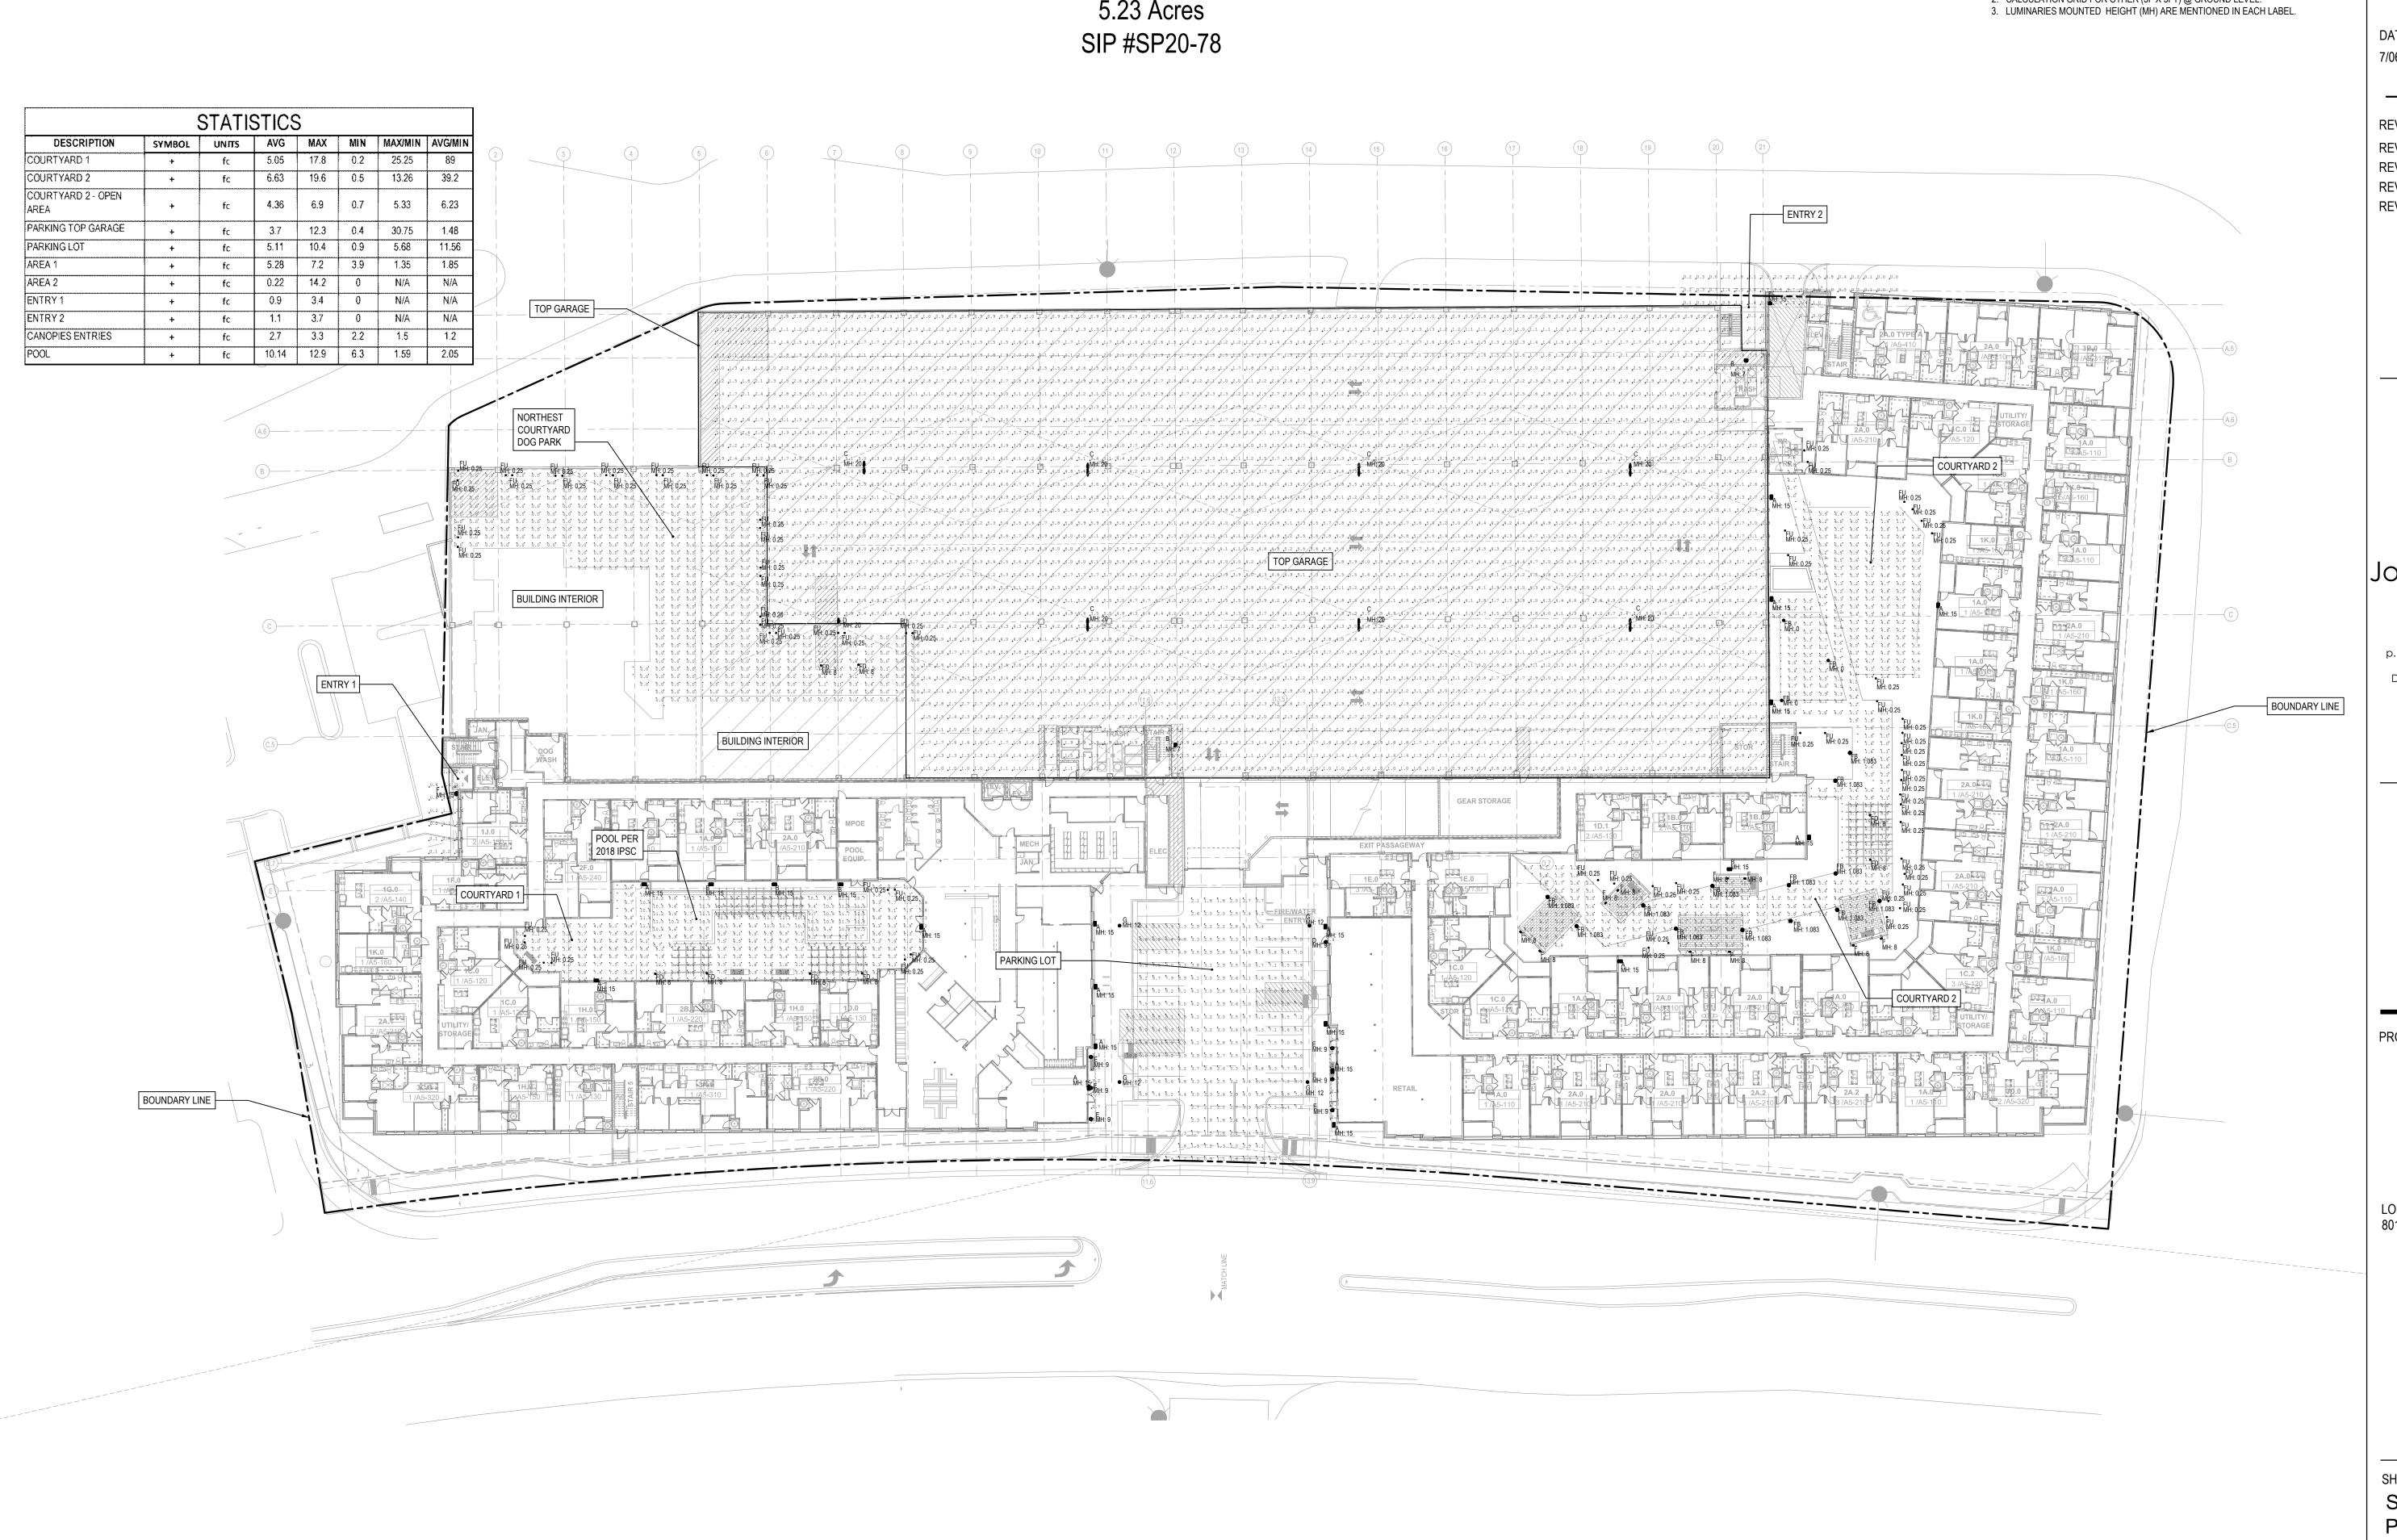



	SITE LIGHT FIXTURE SCHEDULE					
LABEL	QTY	MANUFACTURER CATALOG NO.	DISTRIBUTION TYPE	DESCRIPTION	LED WATTAGE	
Α	17	HUBBELL TRP2-32L-90-4K7-4	TYPE IV	WALLPACK	LED 90W	
В	6	TRP2-32L-90-4K7-3	T YPE III	WALLPACK	LED 90W	
С	7	HUBBELL RAR1-160L-135-4K7-5QW-U	TYPEV	TWO LAMP POLE LIGHT	LED 135W(2)	
D	1	HUBBELL RAR1-160L-135-4K7-5QW-U	TYPEV	SINGLE LAMP POLE LIGHT	LED 135W	
٤	6	HALO SMD4R6930WH	-	DOWNLIGHT	LED 9.7W	
F	2	HUBBELL TRP2-20D-FT-3K7-UNV	WT	WALLPACK	LED 90W	
G	4	STERNBERG LIGHTING 1-1912-XRLED-12L35T3-MDL14-SV1- RLM27	÷	DECORATIVE BASE LIGHT	LED 58W	

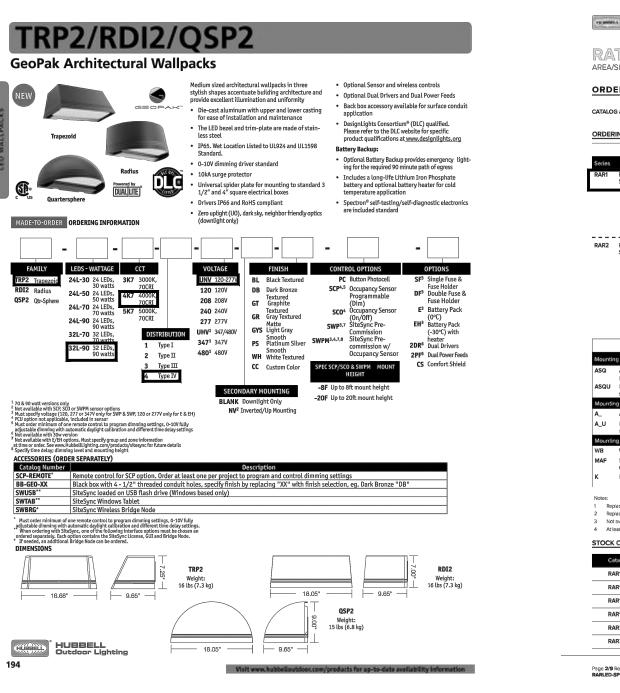


TYPE A

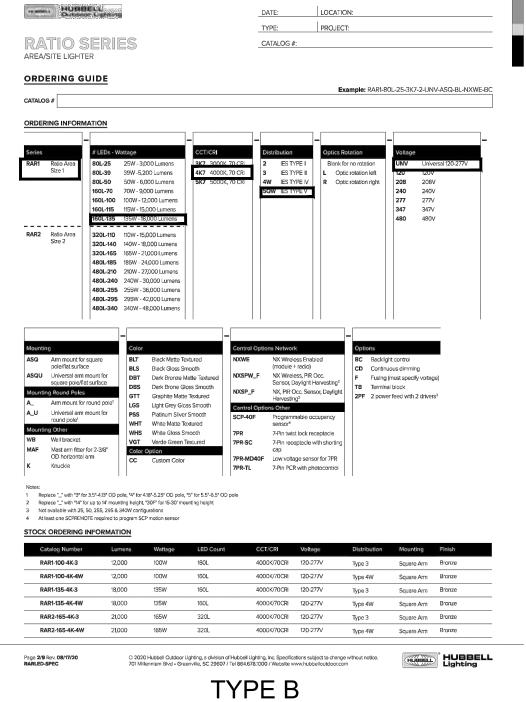


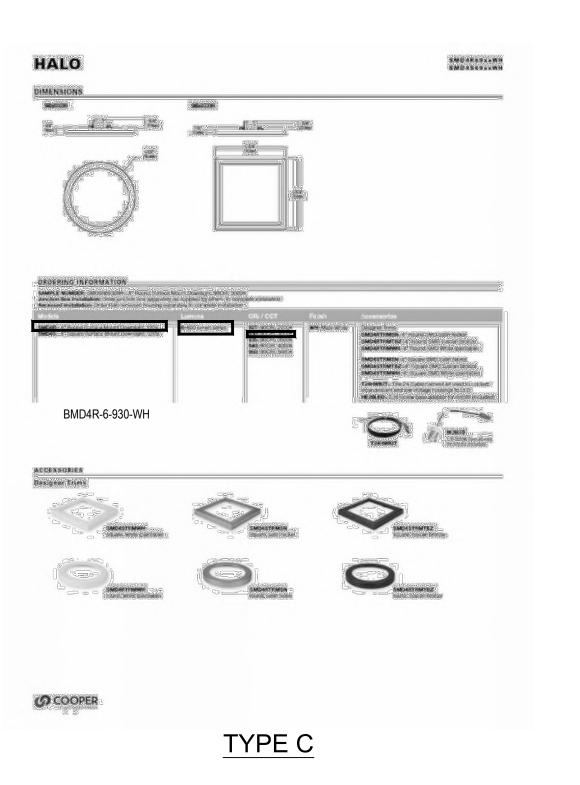

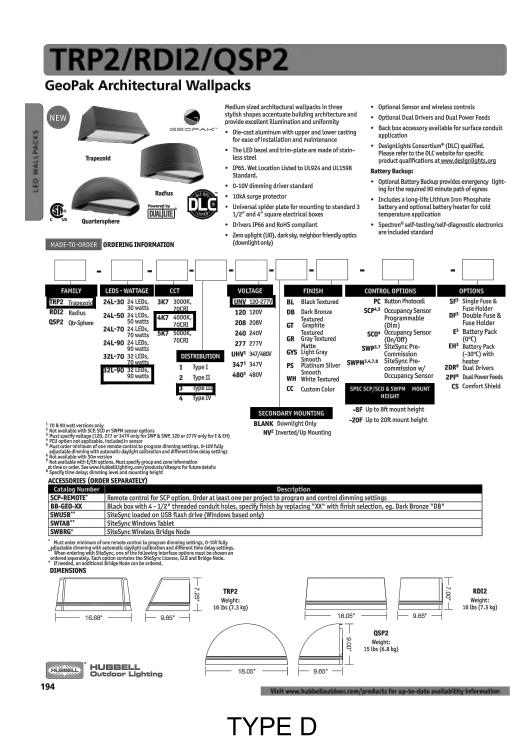

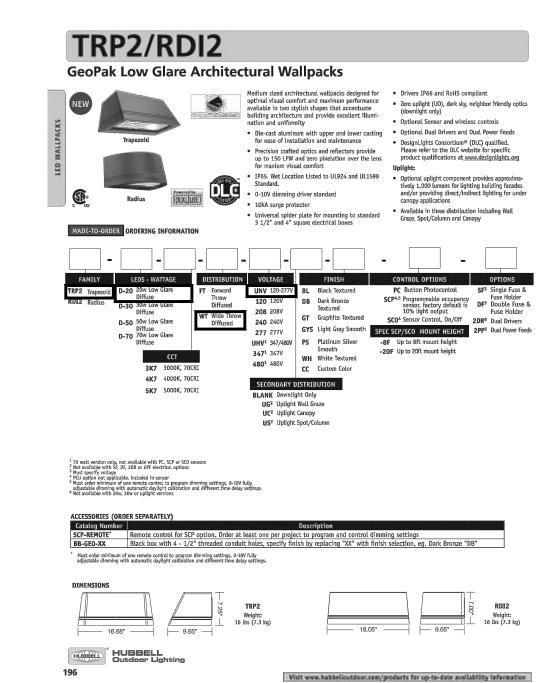



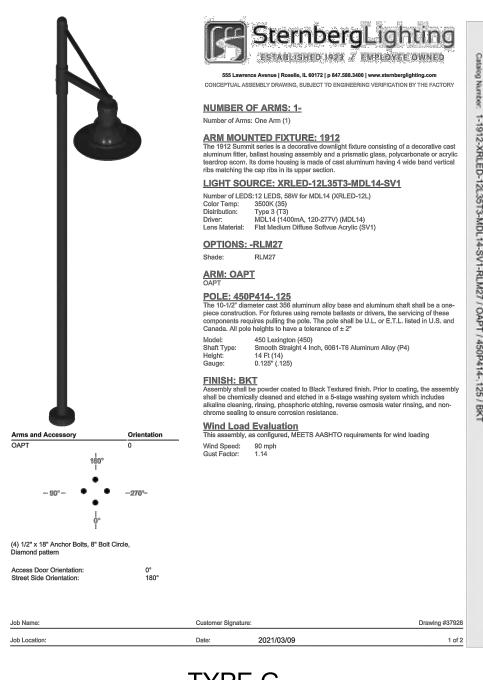

TYPE E

TYPE G

PROJECT NUMBER 65120692

DRAWN BY

DATE 7/06/2021

REVISIONS

REVISION 1 FEB 10, 2021 REVISION 2 MAR 16, 2021 REVISION 3 JUNE 10, 2021 REVISION 4 JULY 6, 2021

Jordan & Skala

Engineers 555 17th Street, • Suite 700 Denver, CO 80202 p. 303.586.2375 • f. 303.586.2376 Project Number: 2080192 Drawn By: EJ Checked By: SL

LINCOLN **STATION APARTMENTS**


LONE TREE, COLORADO


SHEET TITLE LIGHT


SPECIFICTIONS


SHEET NUMBER


	LANDSCAPE LIGHT FIXTURE SCHEDULE							
LABEL QTY MANUFACTURER CATALOG NO. DISTRIBUTION TYPE DESCRIPTION LED WA								
FA	10	ARCHITECTURAL AREA LIGHTING CY1-15-4K7-1-4D-R		WALLPACK	LED 17.3W			
FB	13	HUBBELL KLV190_3L4KUV_BL-H80BL	**	POLE	LED 5.3W			
FD	8	HUBBELL LTC-3RD-W-10L40K8WD-DM1-S-BL	WD	WLLPACK	LED11.9W			
FS	3	HUBBEL LTV83FF-WW-12L4K	SP,NF,WW	IN GRADE	LED 13.8W			
FU	69	KLVL202	-	FEATURE LIGHTING	LED 6.8W			

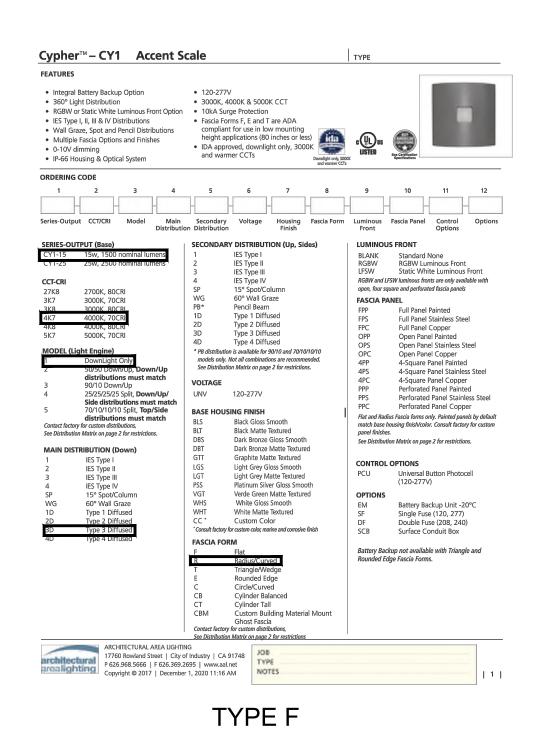

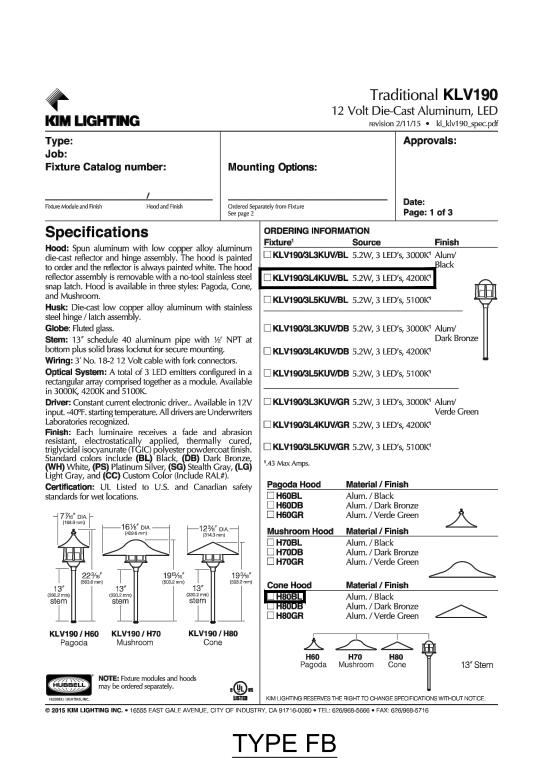

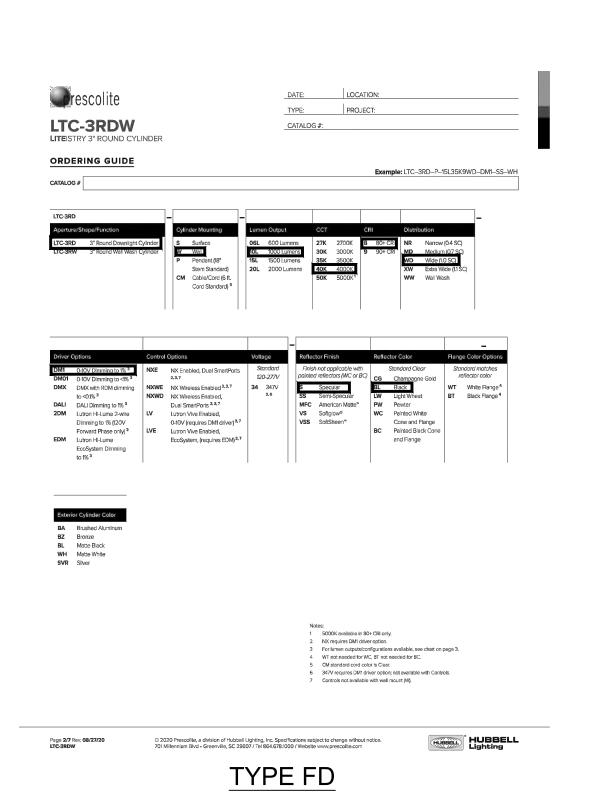

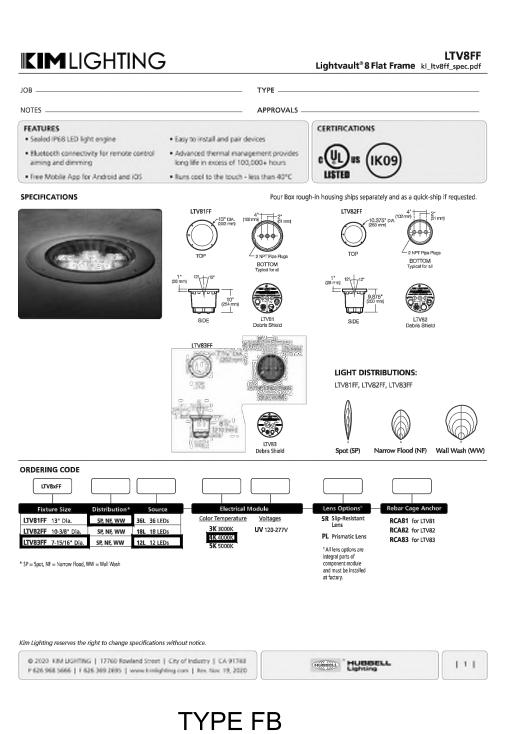

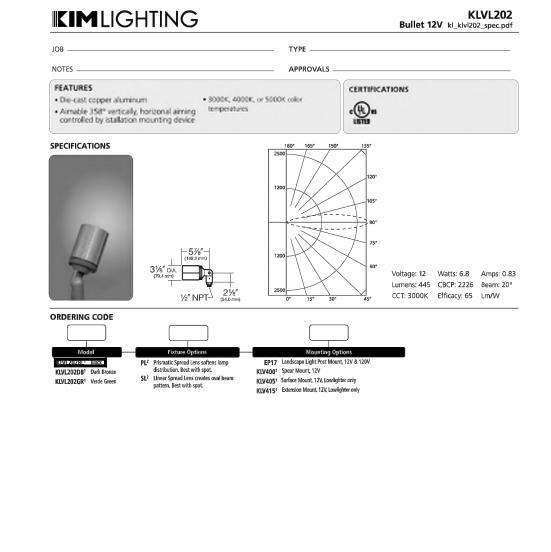

TYPE FU

0 2000 KBN DGHTNG | 17760 Rowland Street | City of Industry | CA 91760 | HUBBELL | 1 | 1 | F626.968 5666 | F626.369.2695 | www.kmilighting.com | Rev. Dec. 22, 2020

Specify finish, BL - Black, DB - Dark Bronze, GR - Verde Green.
 Inserts behind lens.

65120692

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PROJECT NUMBER

DATE 7/06/2021

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REVISION 1 FEB 10, 2021 REVISION 2 MAR 16, 2021 REVISION 3 JUNE 10, 2021 REVISION 4 JULY 6, 2021

JSE Jordan & Skala Engineers

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PROJECT


LINCOLN STATION APARTMENTS


LONE TREE, COLORADO


SHEET TITLE

LIGHT
SPECIFICTIONS

SHEET NUMBER

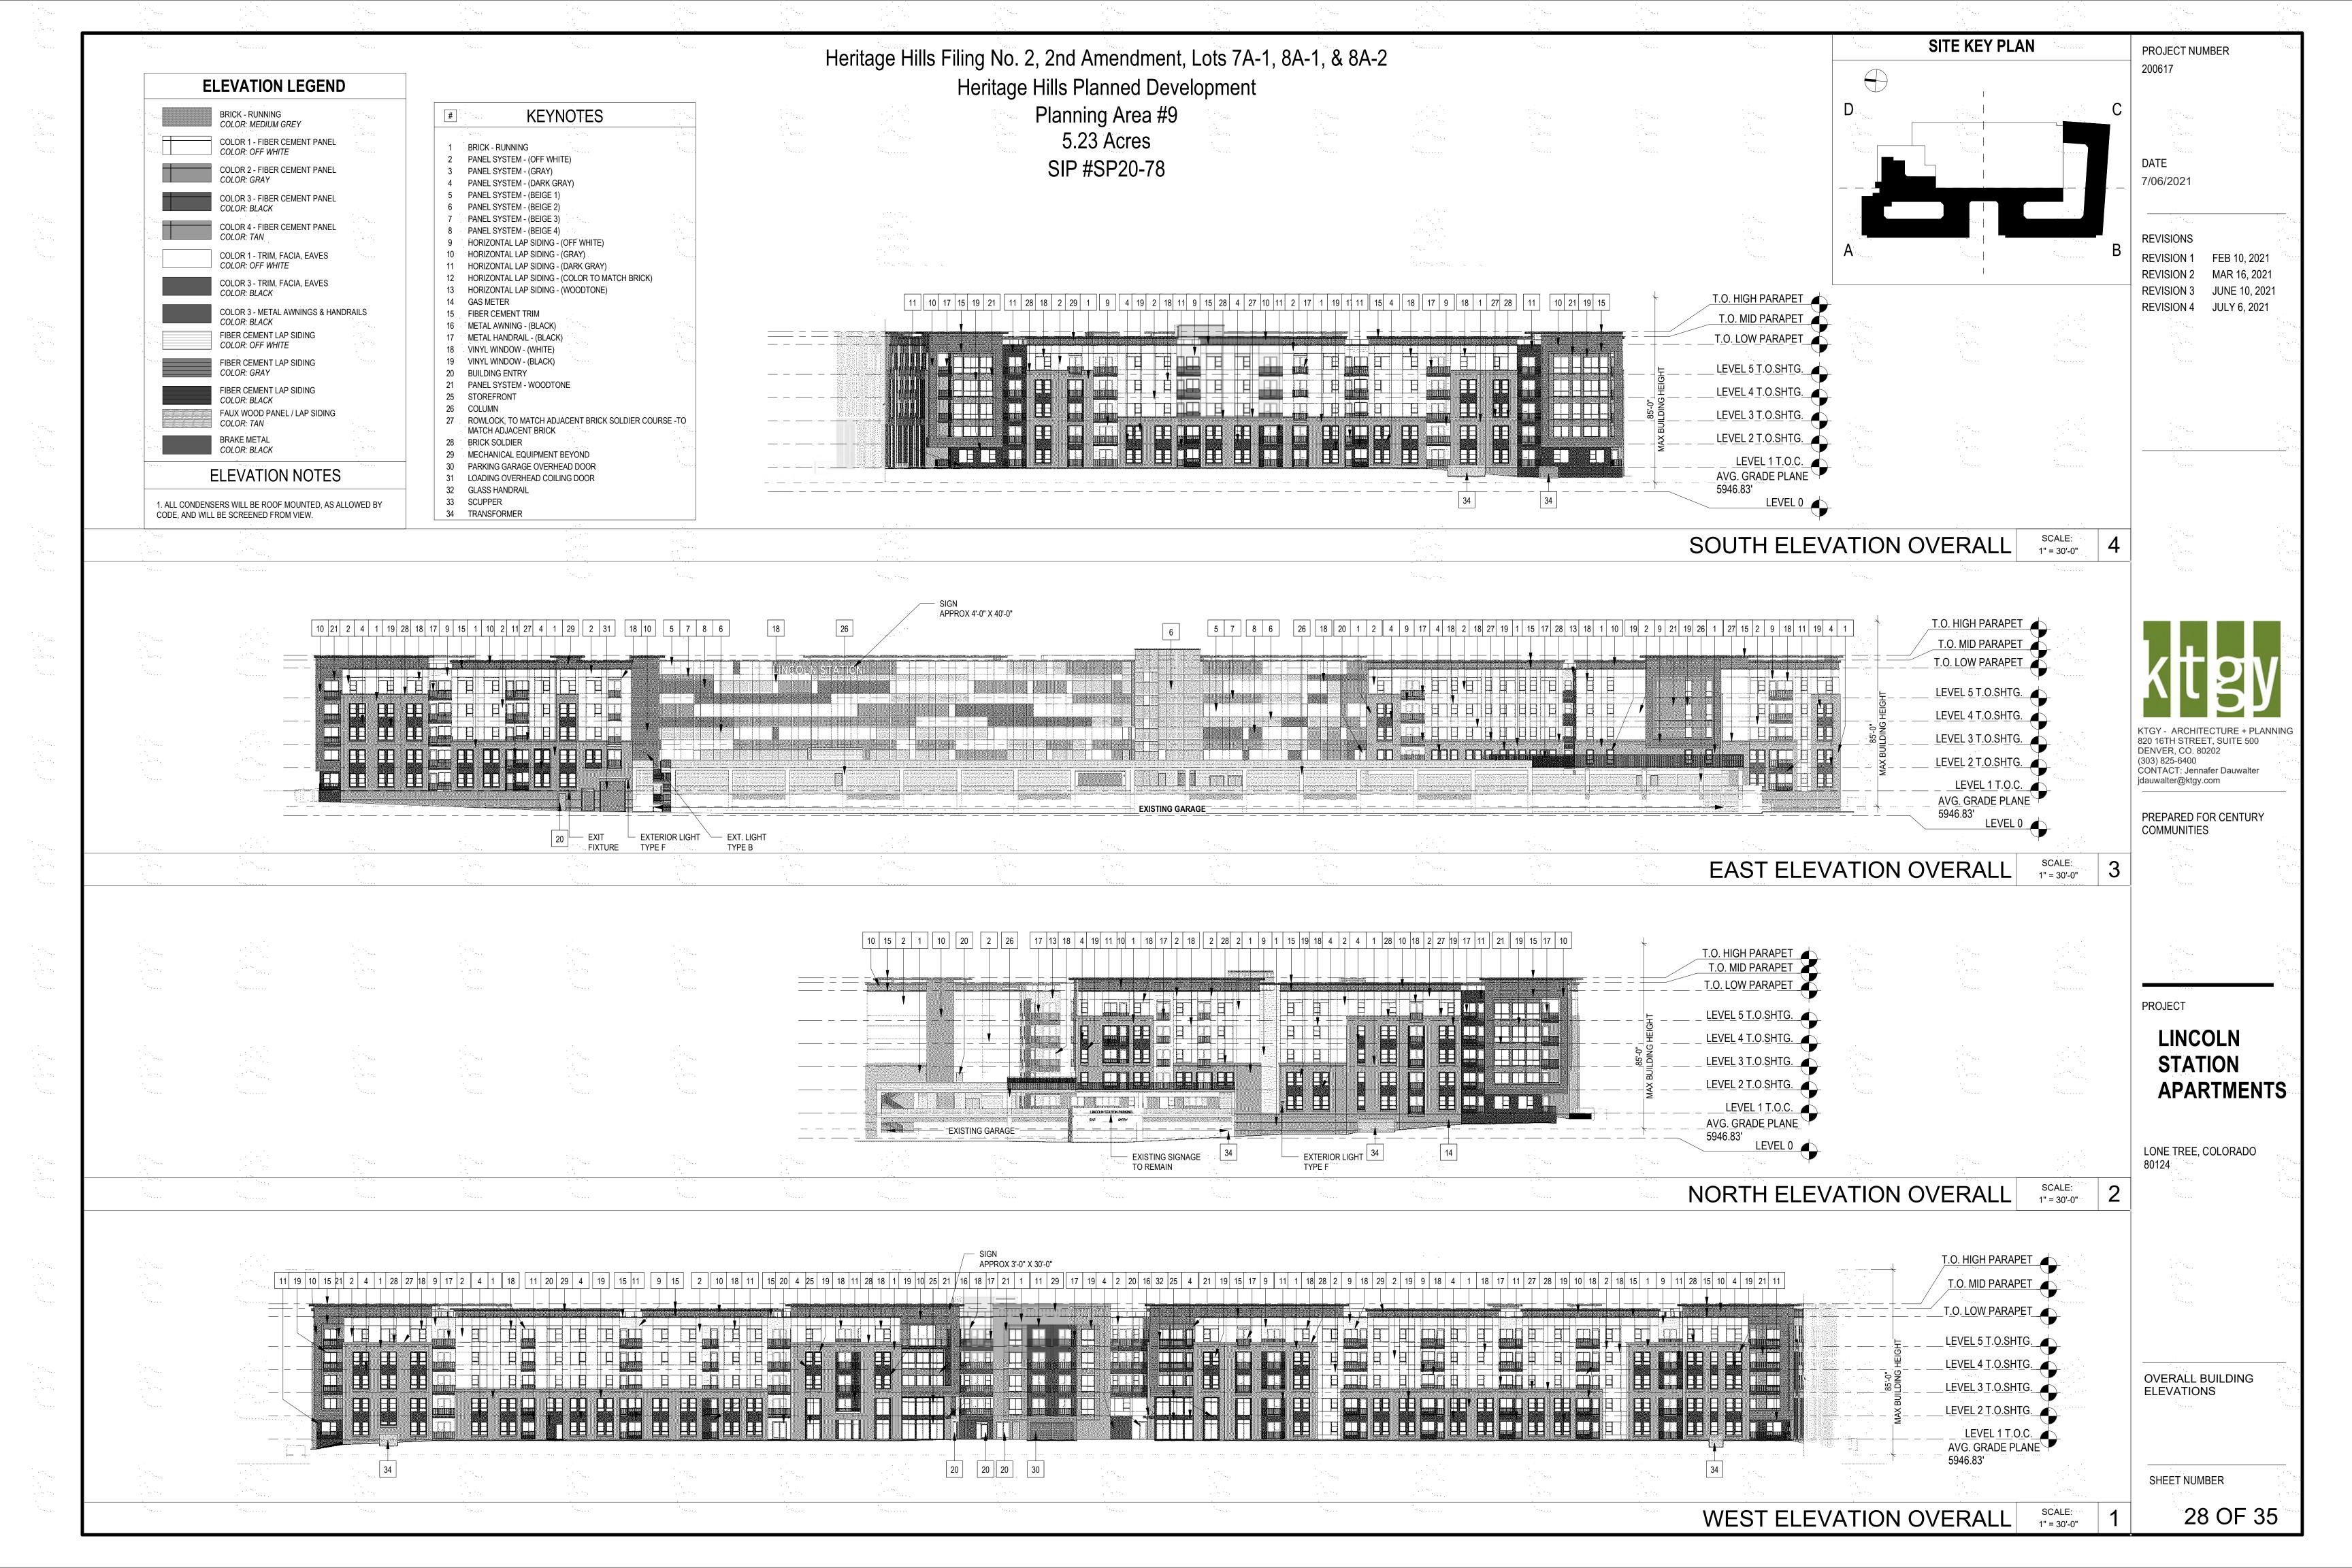

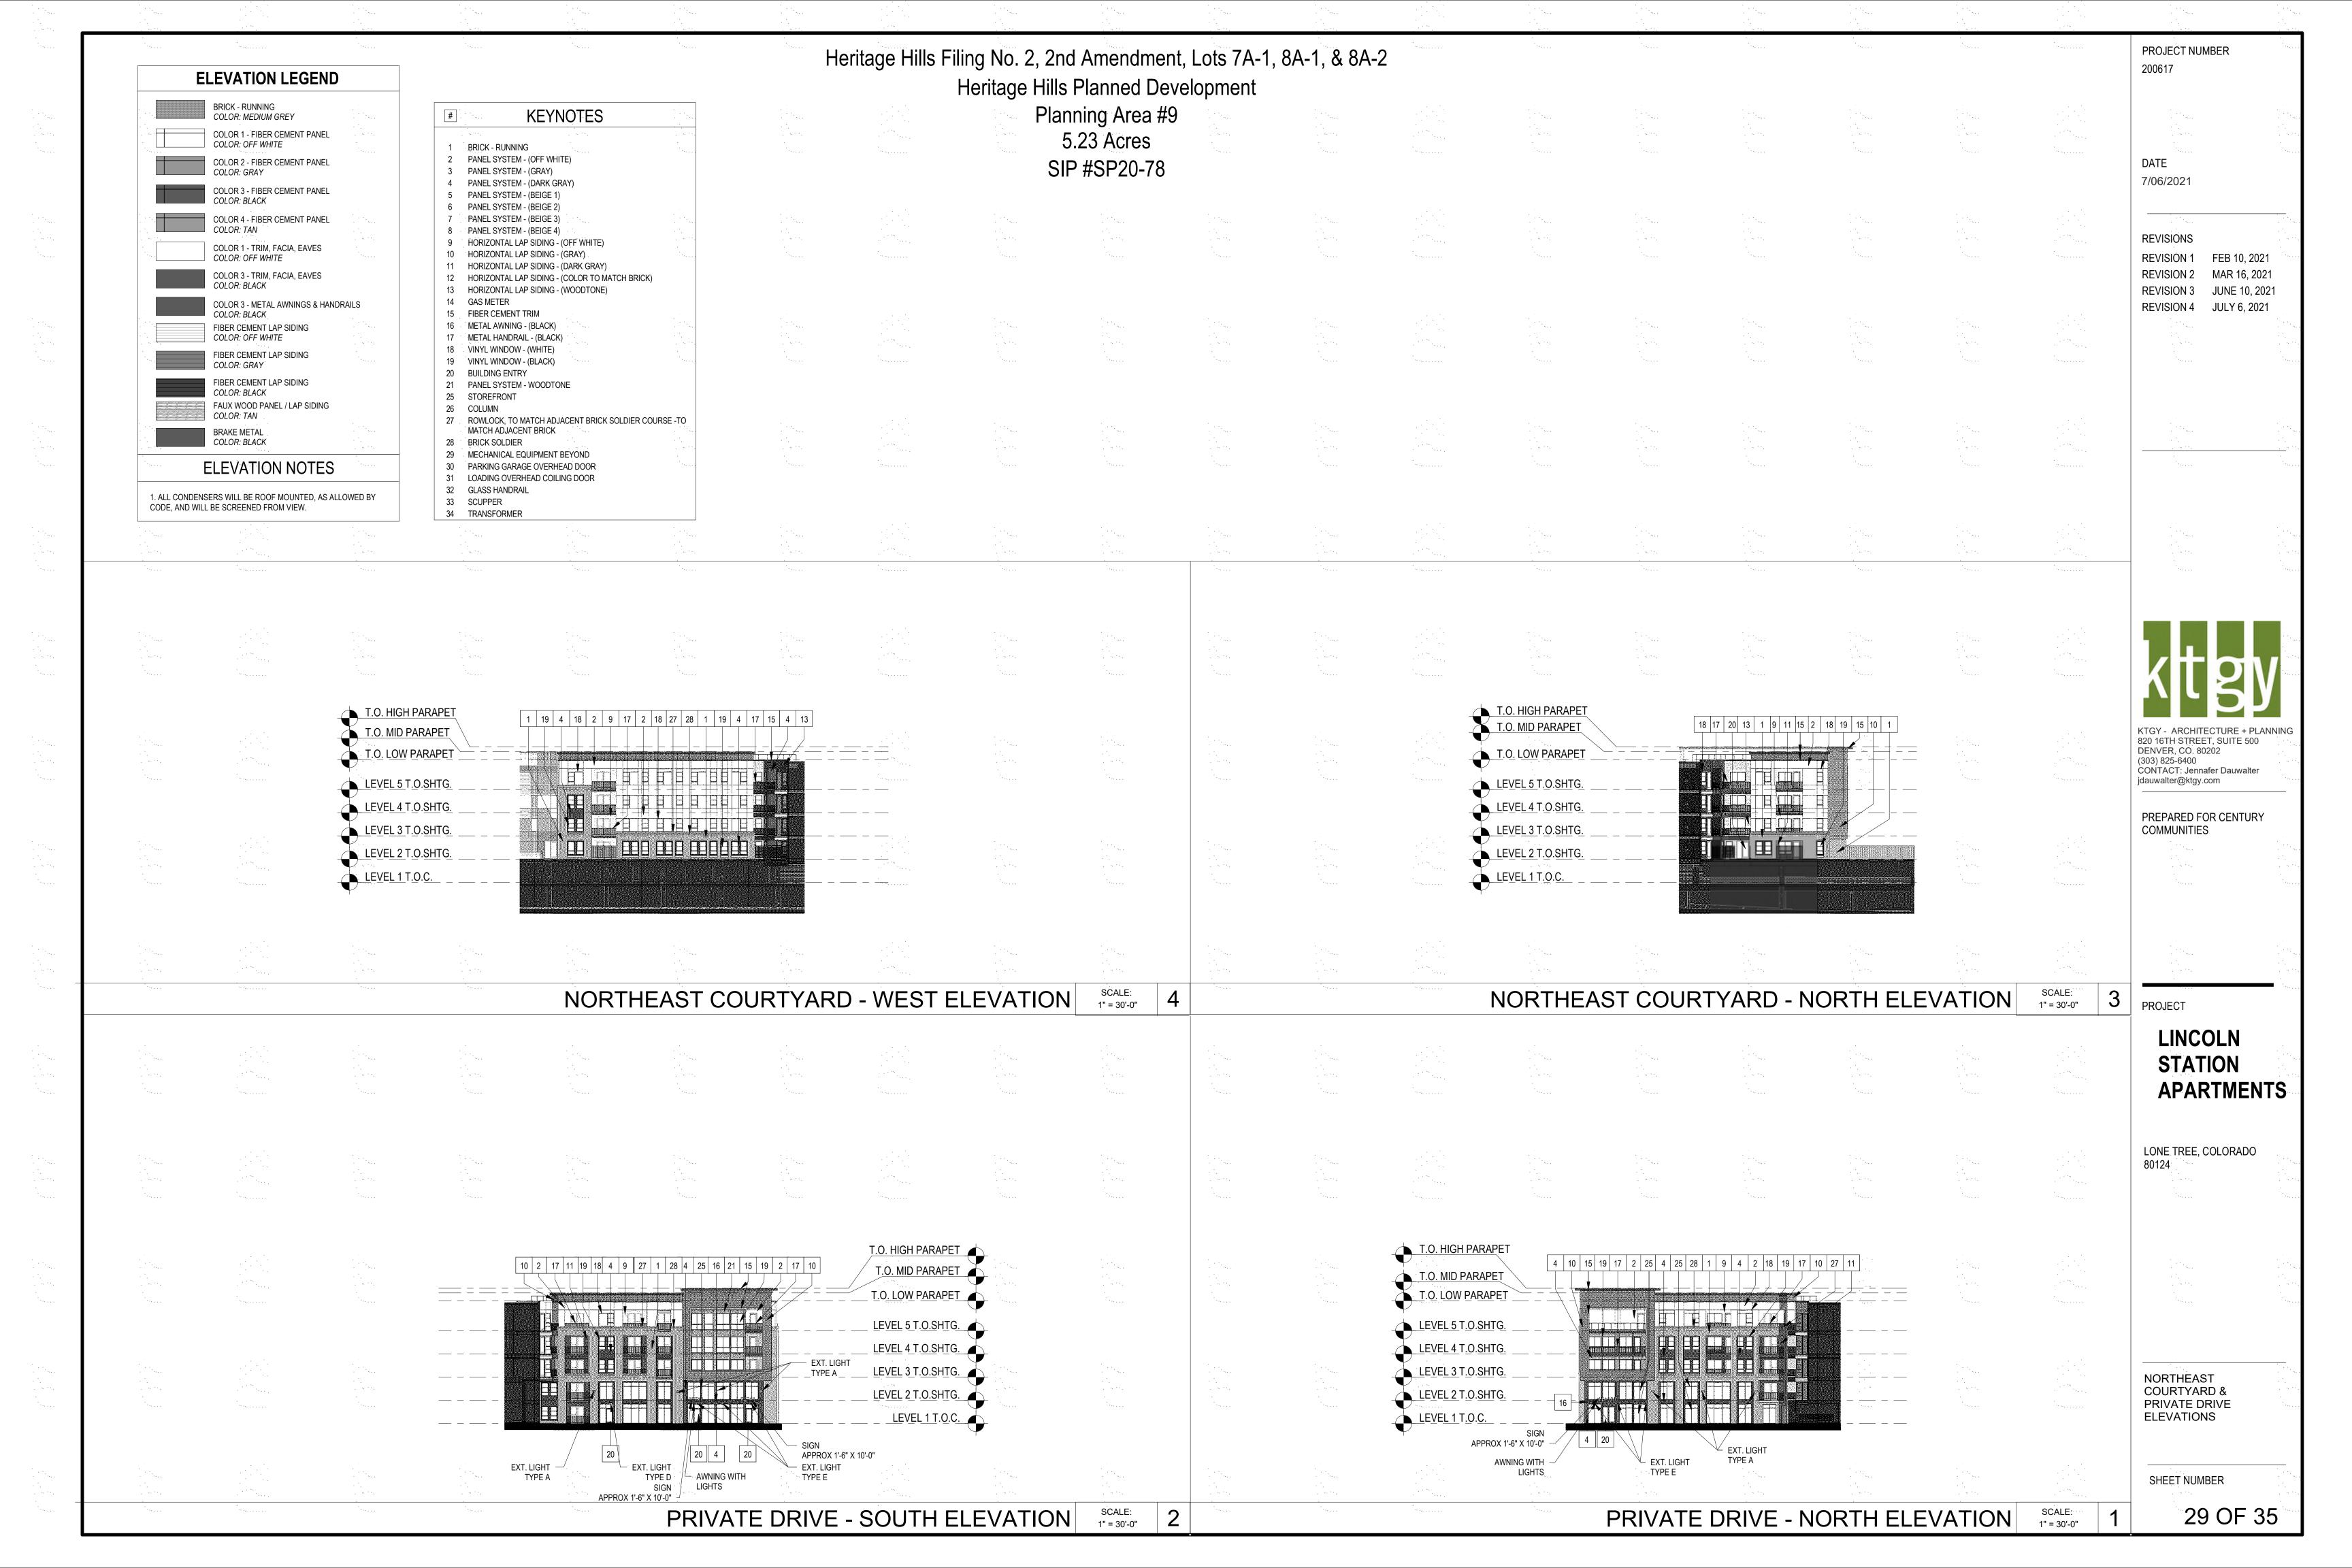

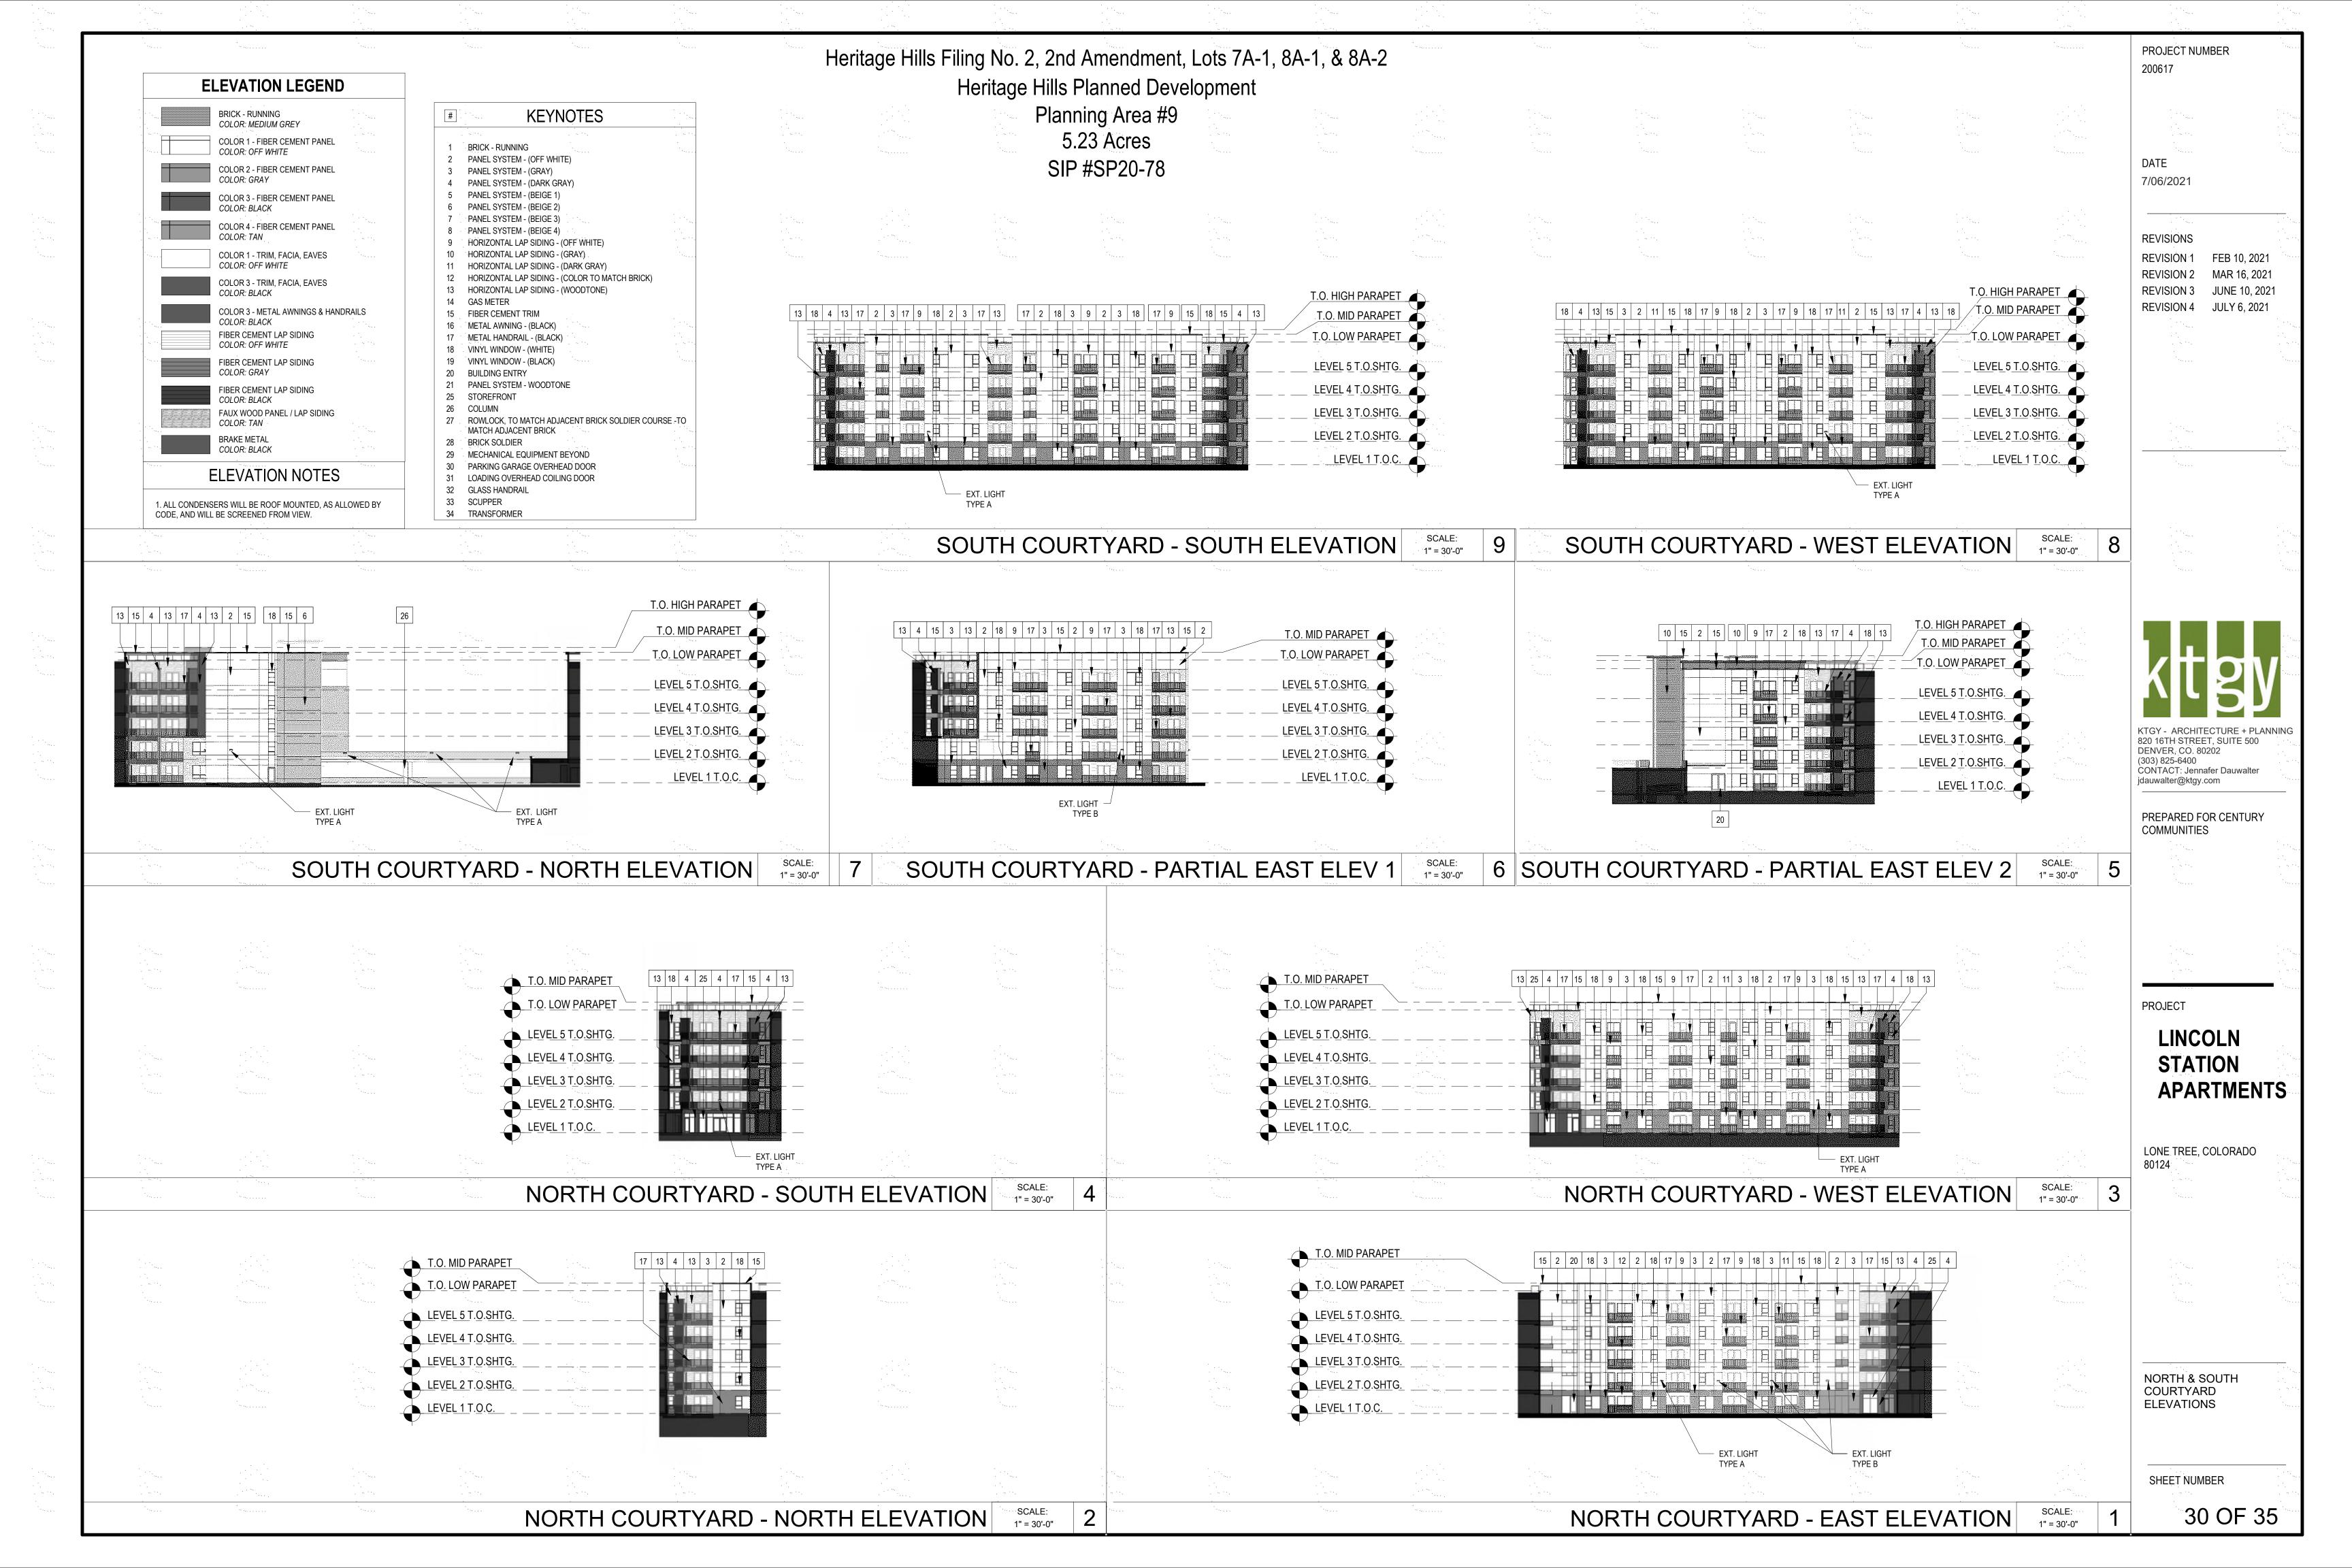



PARK MEADOWS DRIVE SOUTHWEST CORNER



PARK MEADOWS DRIVE NORTHWEST CORNER

PROJECT NUMBER 200617

DATE 7/06/2021

REVISIONS

REVISION 1 FEB 10, 2021 REVISION 2 MAR 16, 2021 REVISION 3 JUNE 10, 2021 REVISION 4 JULY 6, 2021

ktgy

KTGY - ARCHITECTURE + PLANNING 820 16TH STREET, SUITE 500 DENVER, CO. 80202 (303) 825-6400 CONTACT: Jennafer Dauwalter jdauwalter@ktgy.com

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PROJECT

LINCOLN STATION APARTMENTS

LONE TREE, COLORADO 80124

BUILDING RENDERINGS

SHEET NUMBER



NORTH SIDE



LINCOLN STATION NORTHEAST SIDE

PROJECT NUMBER 200617

DATE 7/06/2021

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PROJECT

LINCOLN STATION APARTMENTS

LONE TREE, COLORADO 80124

BUILDING RENDERINGS

SHEET NUMBER



PARK MEADOWS DRIVE PRIVATE DRIVE



LINCOLN STATION SOUTHEAST CORNER

PROJECT NUMBER 200617

DATE 7/06/2021

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LINCOLN STATION APARTMENTS

LONE TREE, COLORADO 80124

BUILDING RENDERINGS

SHEET NUMBER



PARK MEADOWS DRIVE AT PRIVATE DRIVE LOOKING TOWARDS LEASING



NORTH COURTYARD LOOKING SOUTH

PROJECT NUMBER 200617

DATE 7/06/2021

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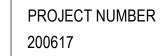
PROJECT

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BUILDING RENDERINGS

SHEET NUMBER



DATE 7/06/2021

REVISIONS


REVISION 1 FEB 10, 2021
REVISION 2 MAR 16, 2021
REVISION 3 JUNE 10, 2021
REVISION 4 JULY 6, 2021



NORTHEAST COURTYARD/DOG PARK



SOUTH COURTYARD LOOKING WEST

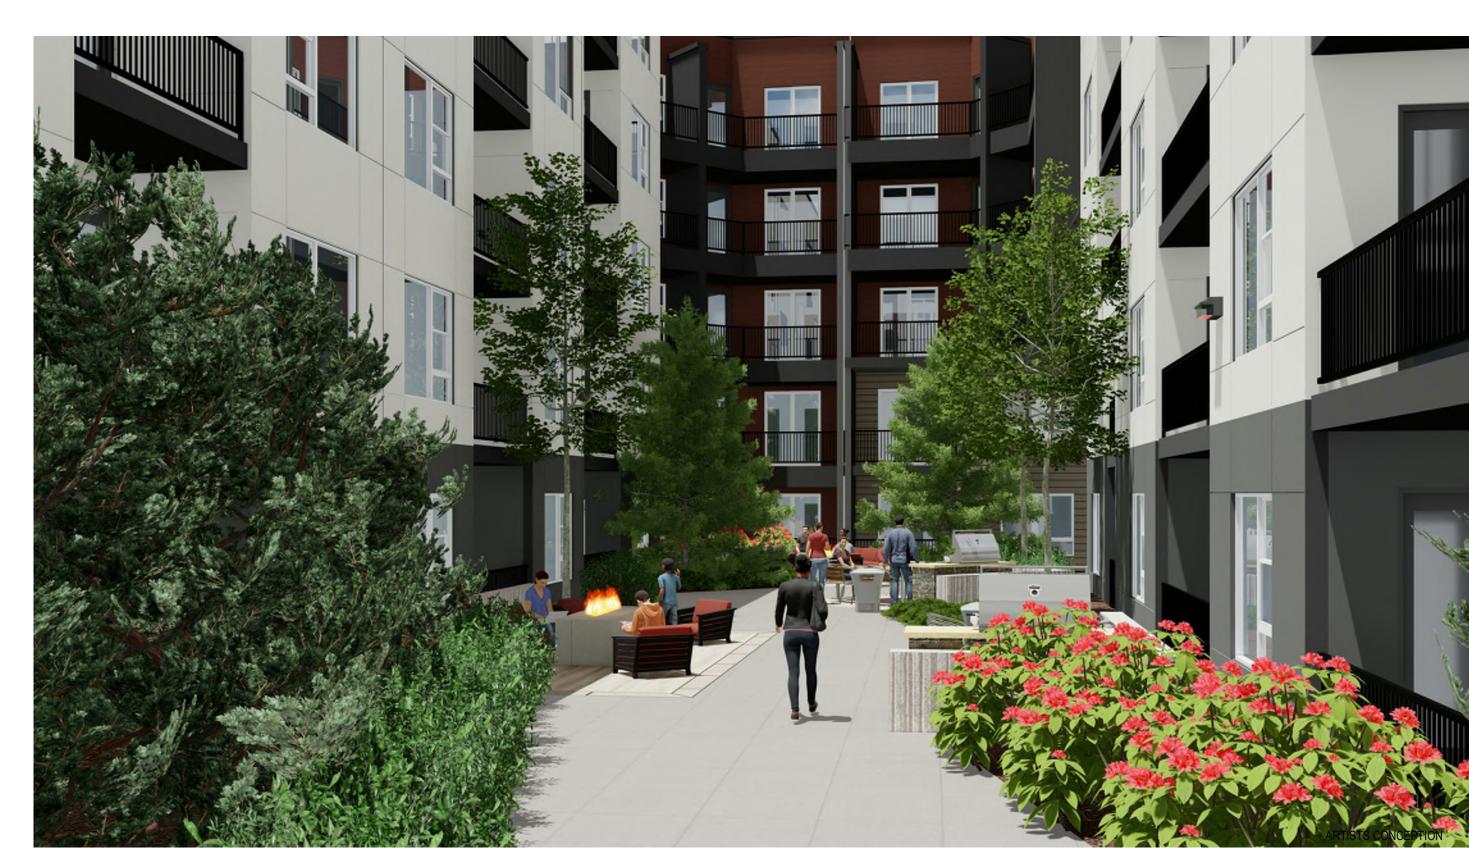

SOUTH COURTYARD LOOKING NORTH



SOUTH COURTYARD LOOKING SOUTH



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PREPARED FOR CENTURY COMMUNITIES

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LINCOLN STATION APARTMENTS

LONE TREE, COLORADO 80124

BUILDING RENDERINGS

SHEET NUMBER